

Vide			$\perp$
\05 Site-\		PRELIMINARY DRAWING	
1007		DRAWING	
ņ			
-01299			/c\
		NOT ISSUED FOR CONSTRUCTION	/B\
7\66		CONSTRUCTION	Rev
:\01299\200	REFERENCE		1100
n			


ENGINEER'S SEAL

				Scale: AS SHOWN	Issued for:
				Designed by: CC	
				Drawn by: VH	
				Checked by: VS	
				Approved by: VS	
	2021 FEASIBILITY STUDY	VH	12/16/2021	THE CONTENT OF THIS DOCUMENT IS NOT INTENDED FOR THE USE OF, NOR IS IT	
C	ADDRESSED 08/2017 CLIENT COMMENTS	DF	11/03/2017	INTENDED TO BE RELIED UPON BY ANY PERSON, FIRM OR CORPORATION OTHER THAN THE CLIENT AND TETRA TECH. TETRA TECH DENIES ANY LIABILITY	
В	PRELIMINARY DESIGN ISSUED FOR REVIEW	JC	05/12/2017	WHATSOEVER TO OTHER PARTIES FOR DAMAGES OR INJURY SUFFERED BY SUCH THIRD PARTY ARISING FROM THE USE OF THIS DOCUMENT BY THEM. WITHOUT	
A	PRELIMINARY DESIGN	СС	04/21/2017	THE EXPRESSED WRITTEN AUTHORITY OF TETRA TECH AND OUR CLIENT. THIS DOCUMENT IS SUBJECT TO FURTHER RESTRICTIONS IMPOSED BY THE CONTRACT	19
Rev	Description	BY	Date	BETWEEN THE CLIENT AND TETRA TECH AND THESE PARTIES PERMISSION MUST  BE SOUGHT REGARDING THIS DOCUMENT IN ALL OTHER CIRCUMSTANCES.	
	REVISIONS	•		BE SOUGHT REGARDING THIS DOCUMENT IN ALL OTHER GIRCUMSTANCES.	







Issued by:

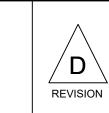



Project: 2021 MT TODD FEASIBILITY STUDY DRAINAGE DESIGN	Project no.: 200-01299-21007	
Location: NORTHERN TERRITORY, AUSTRAL	.IA	Date: 12/16/2021


4520-DC-111C SHEET 12 OF 34

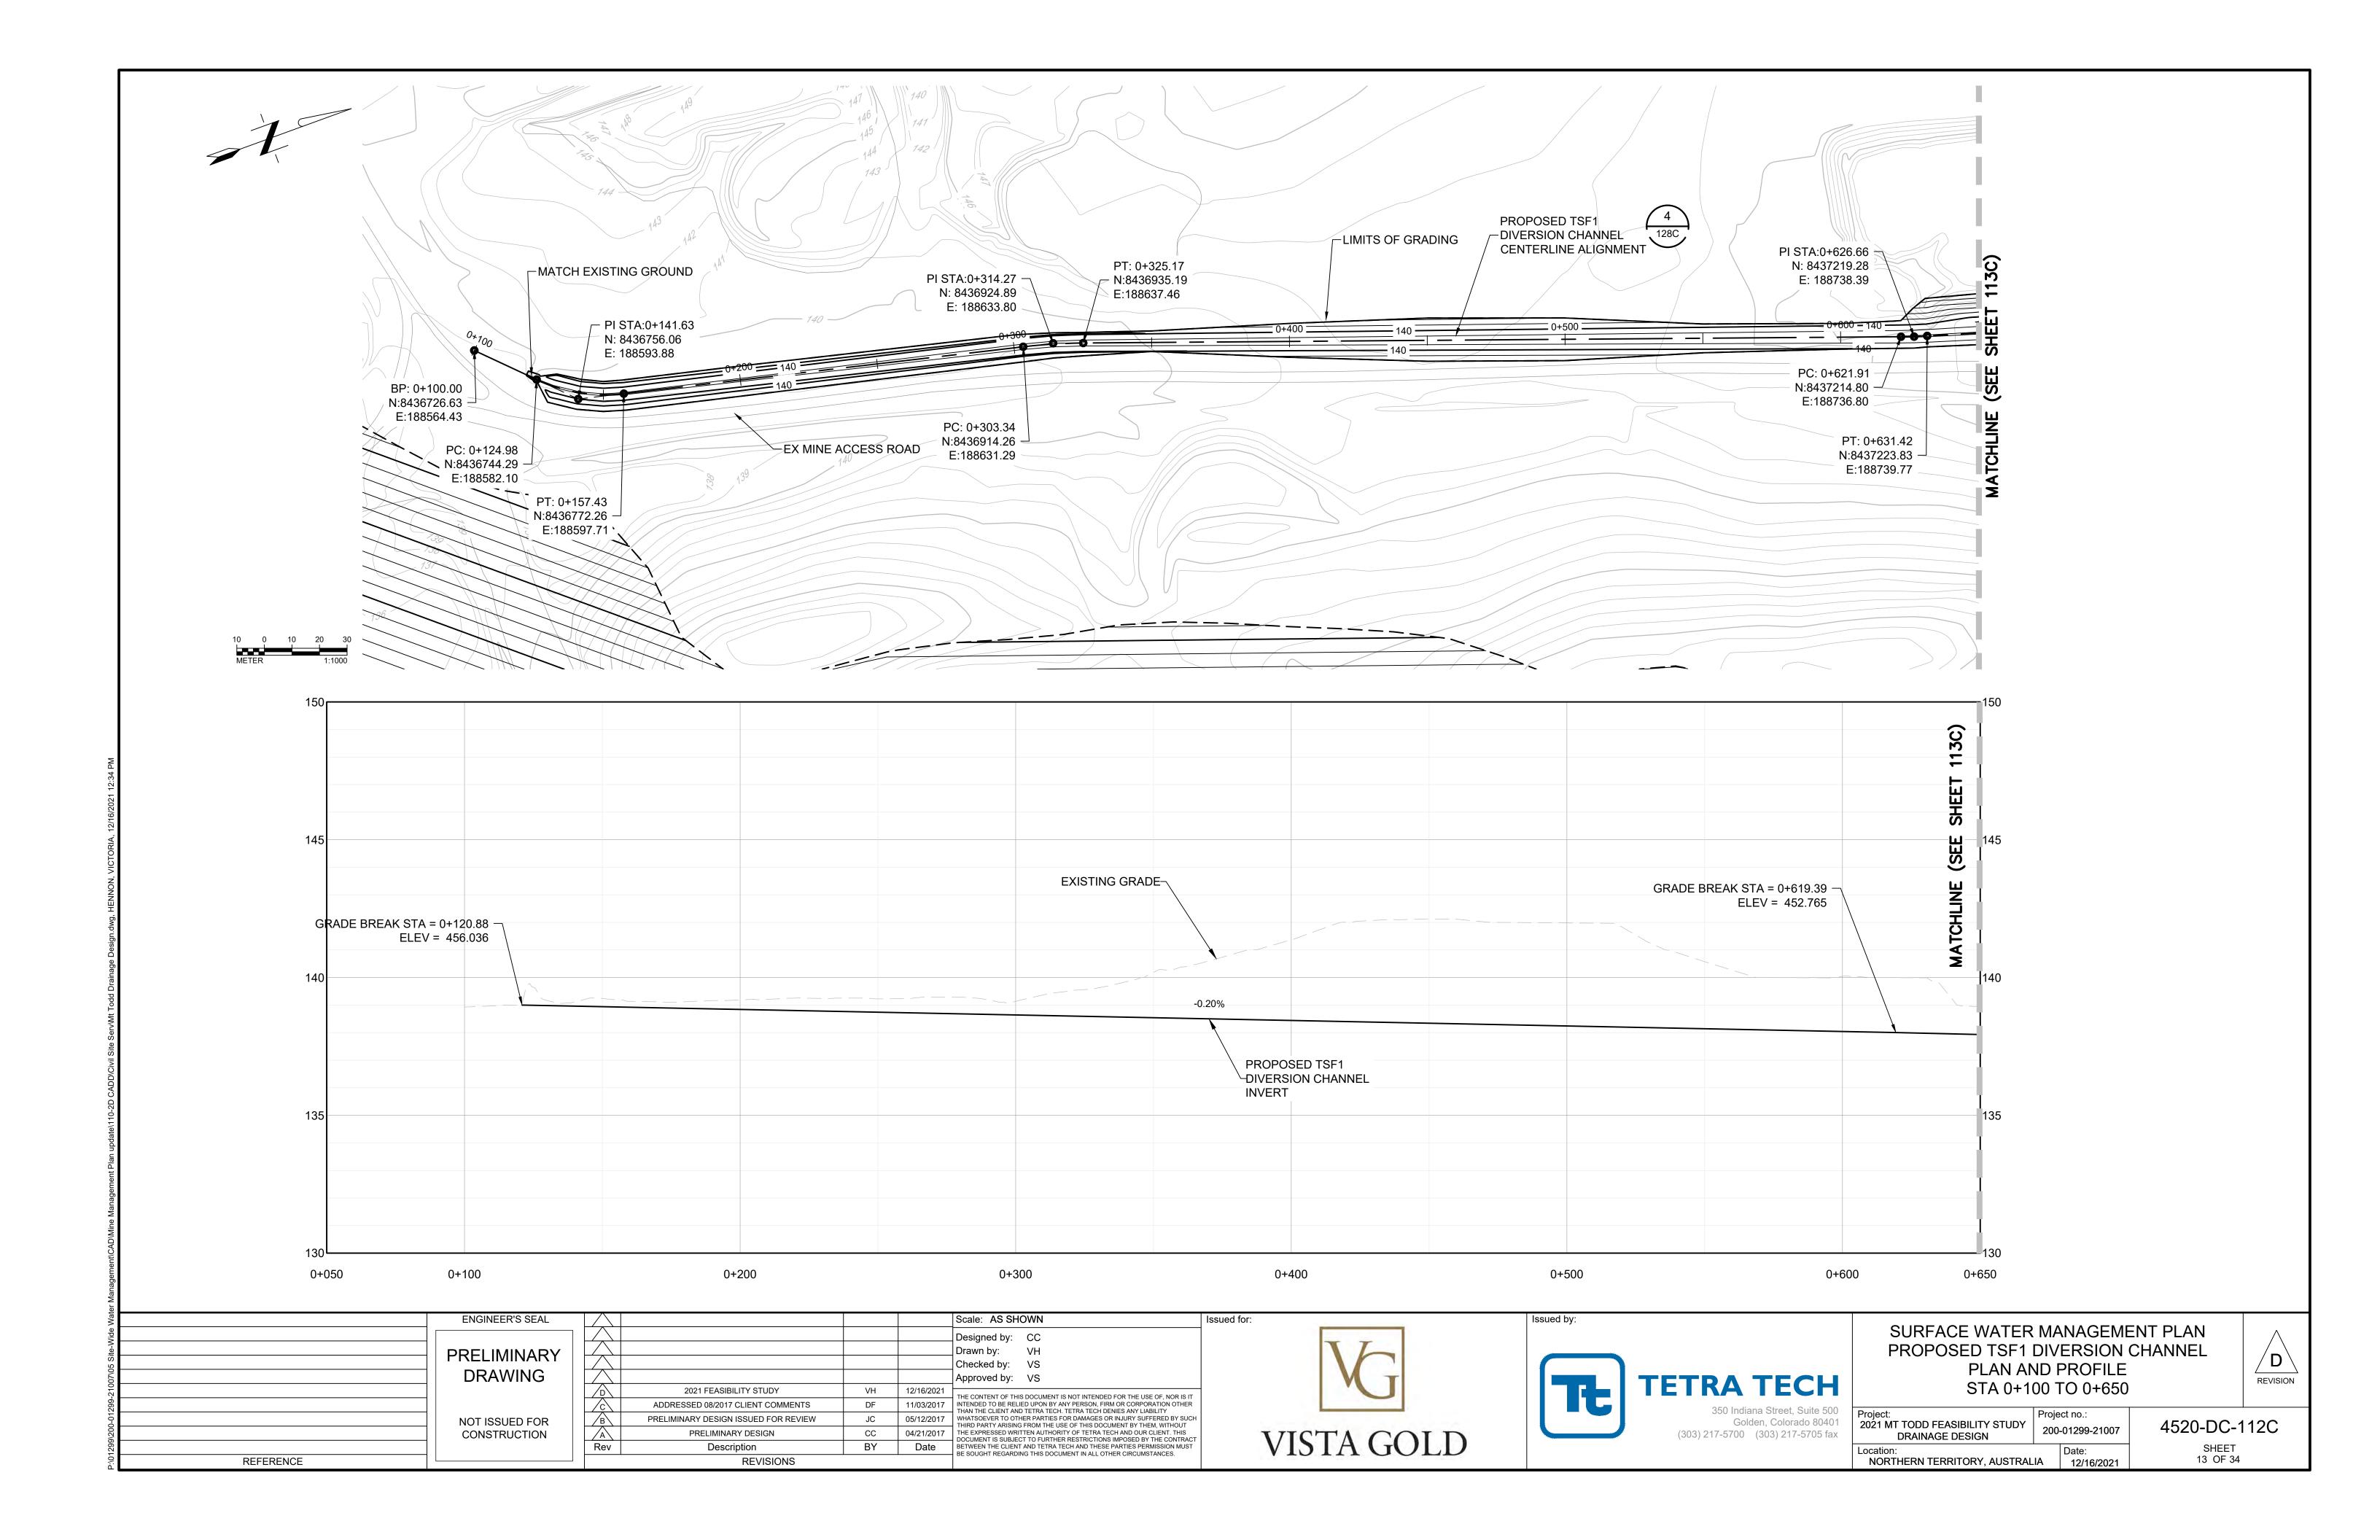


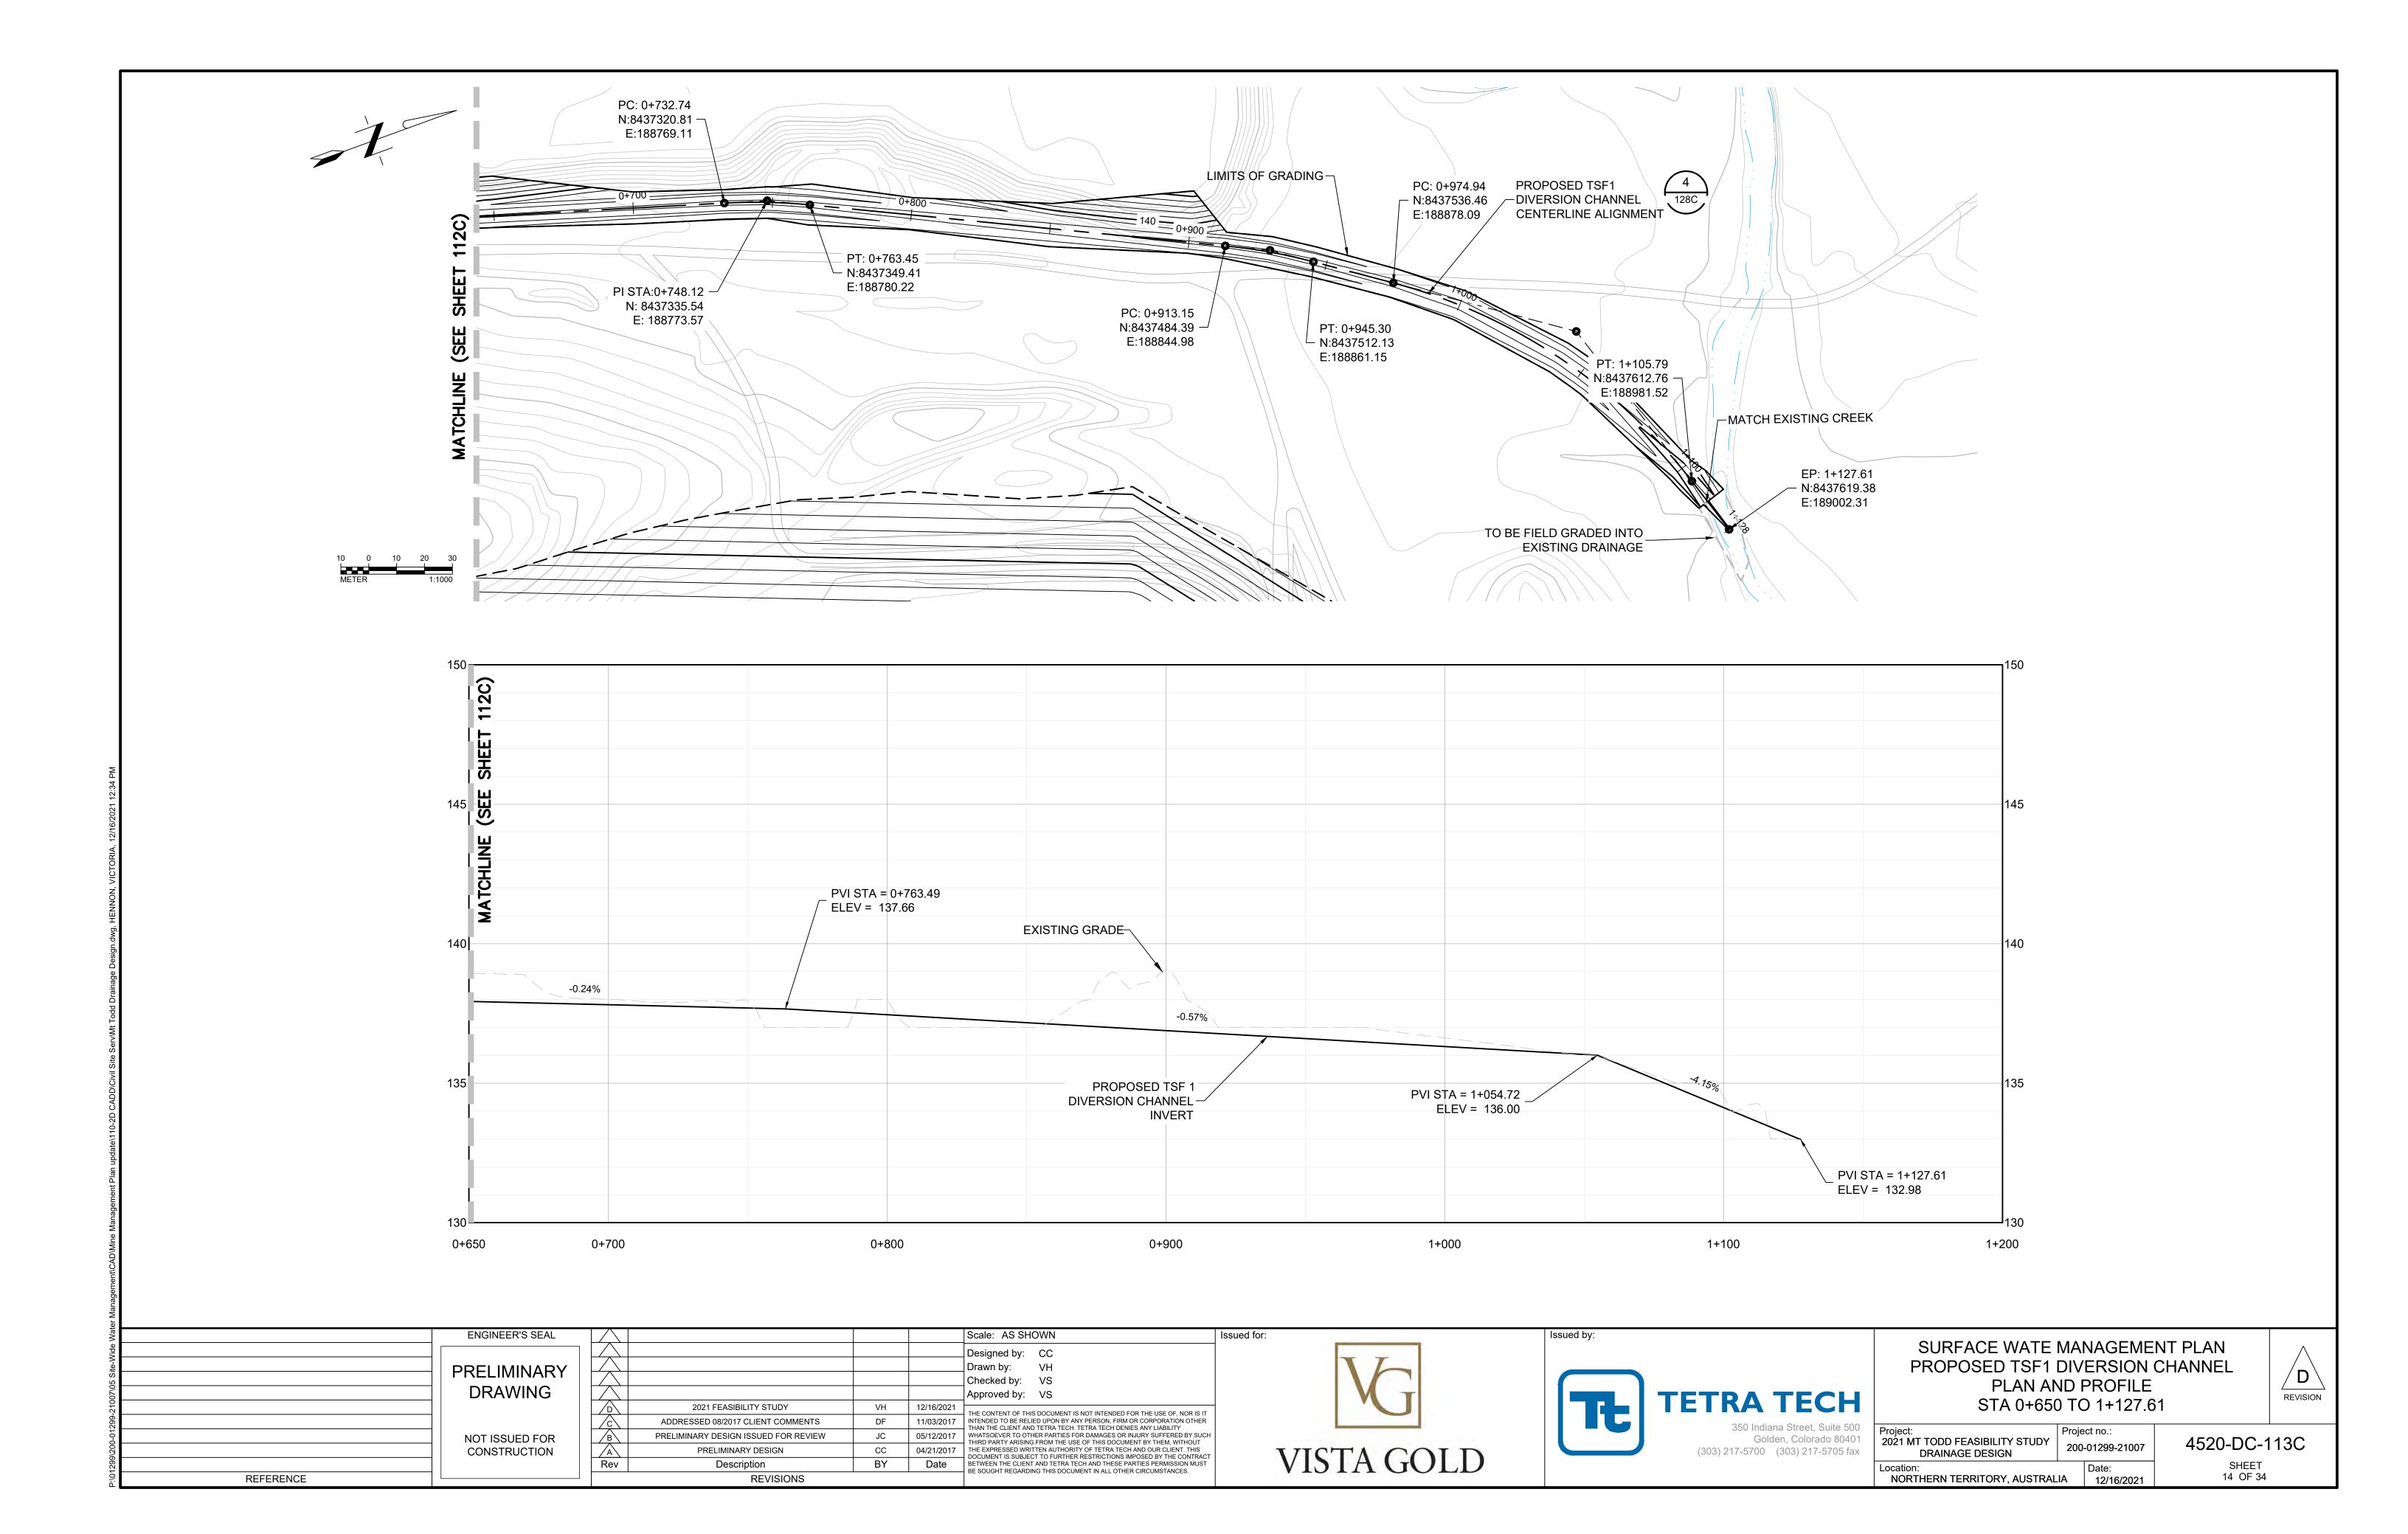


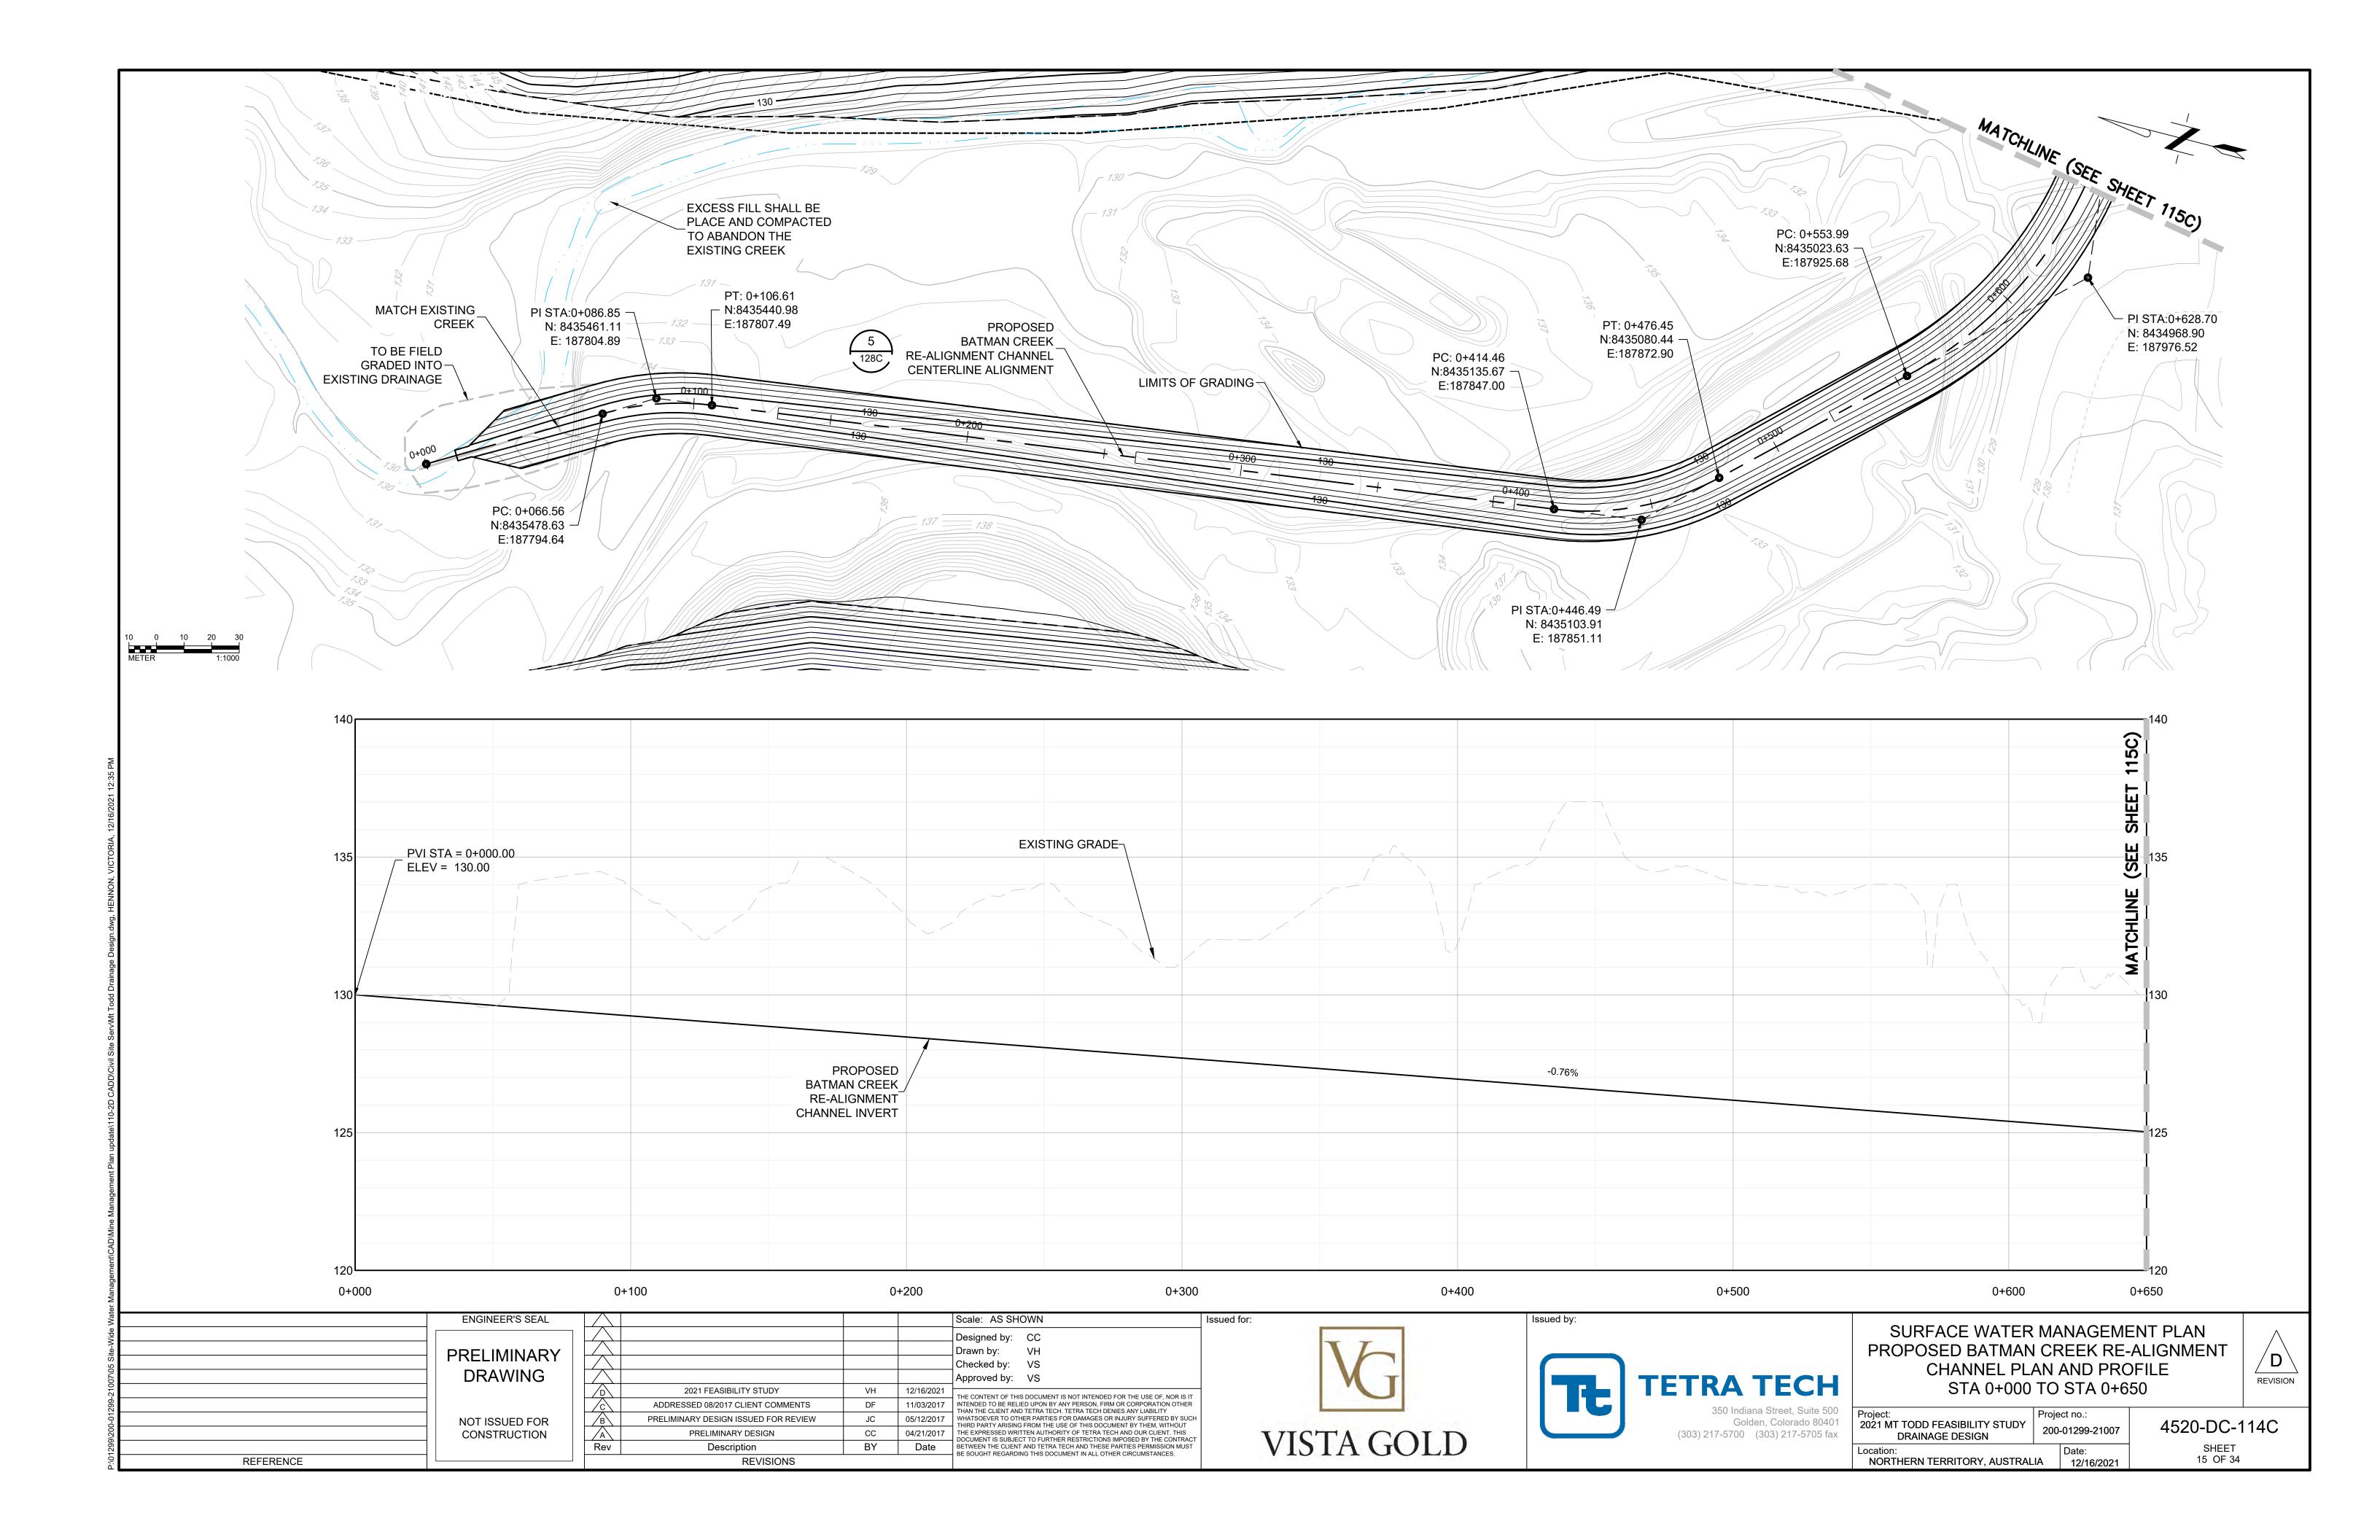


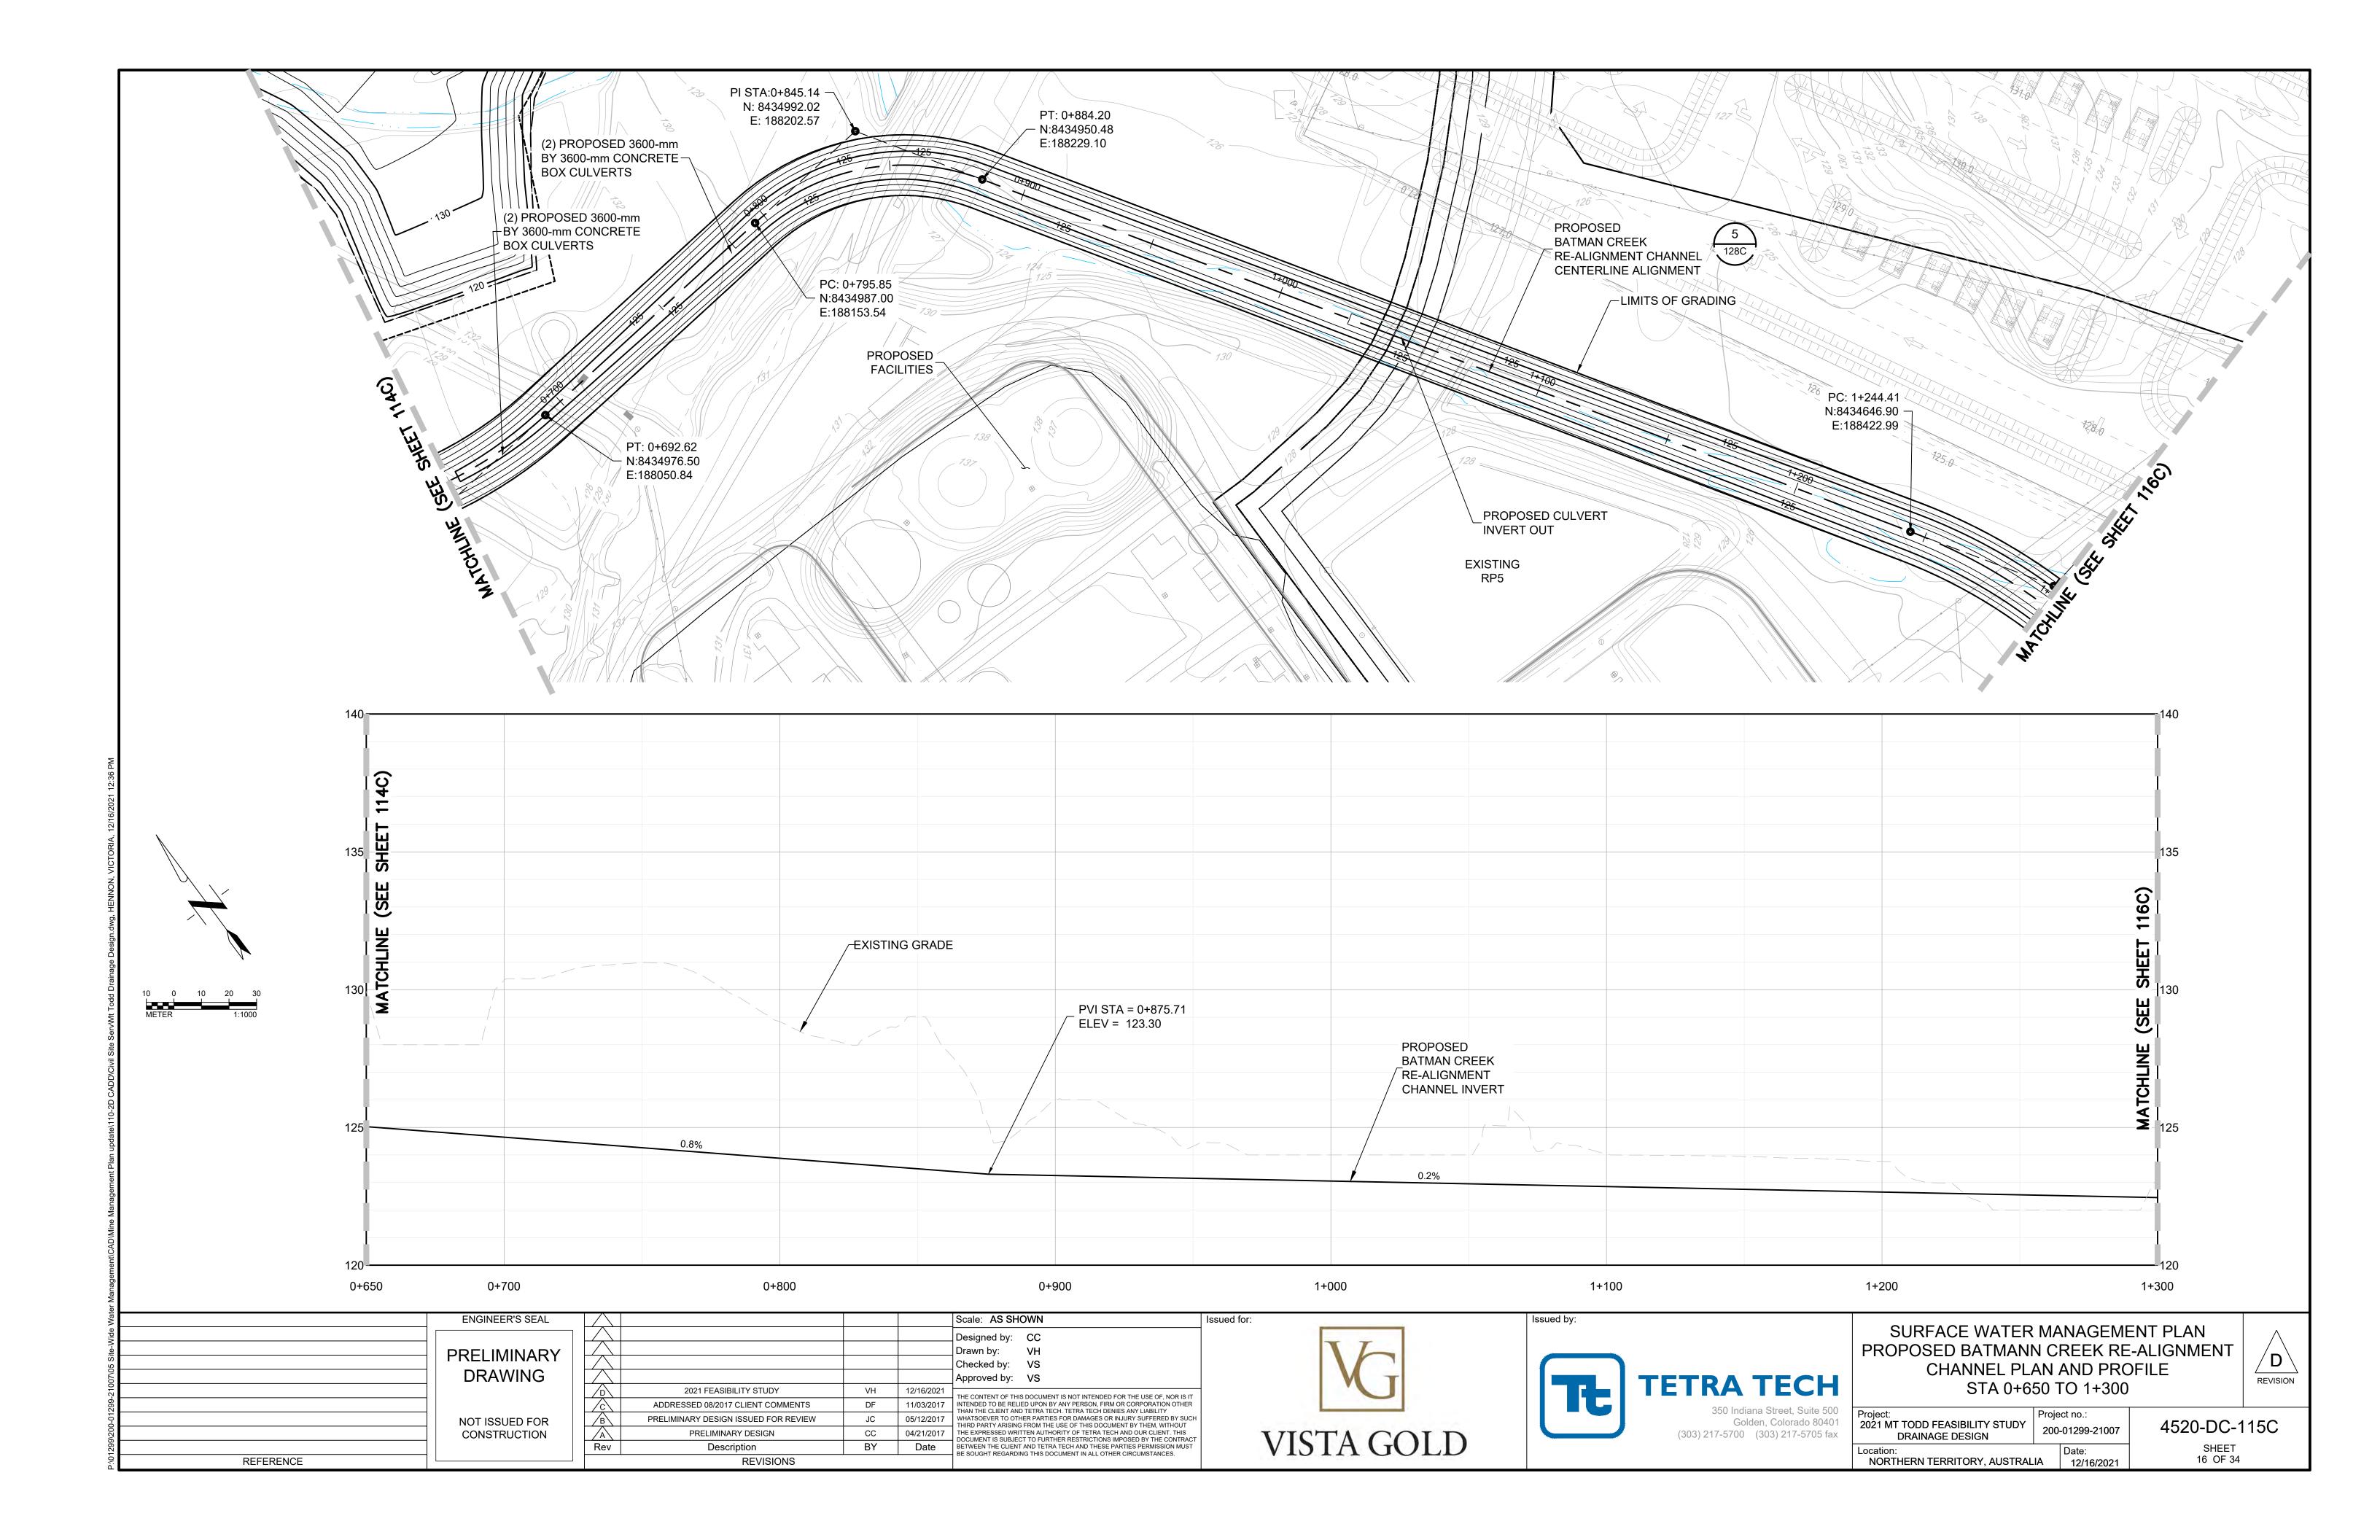


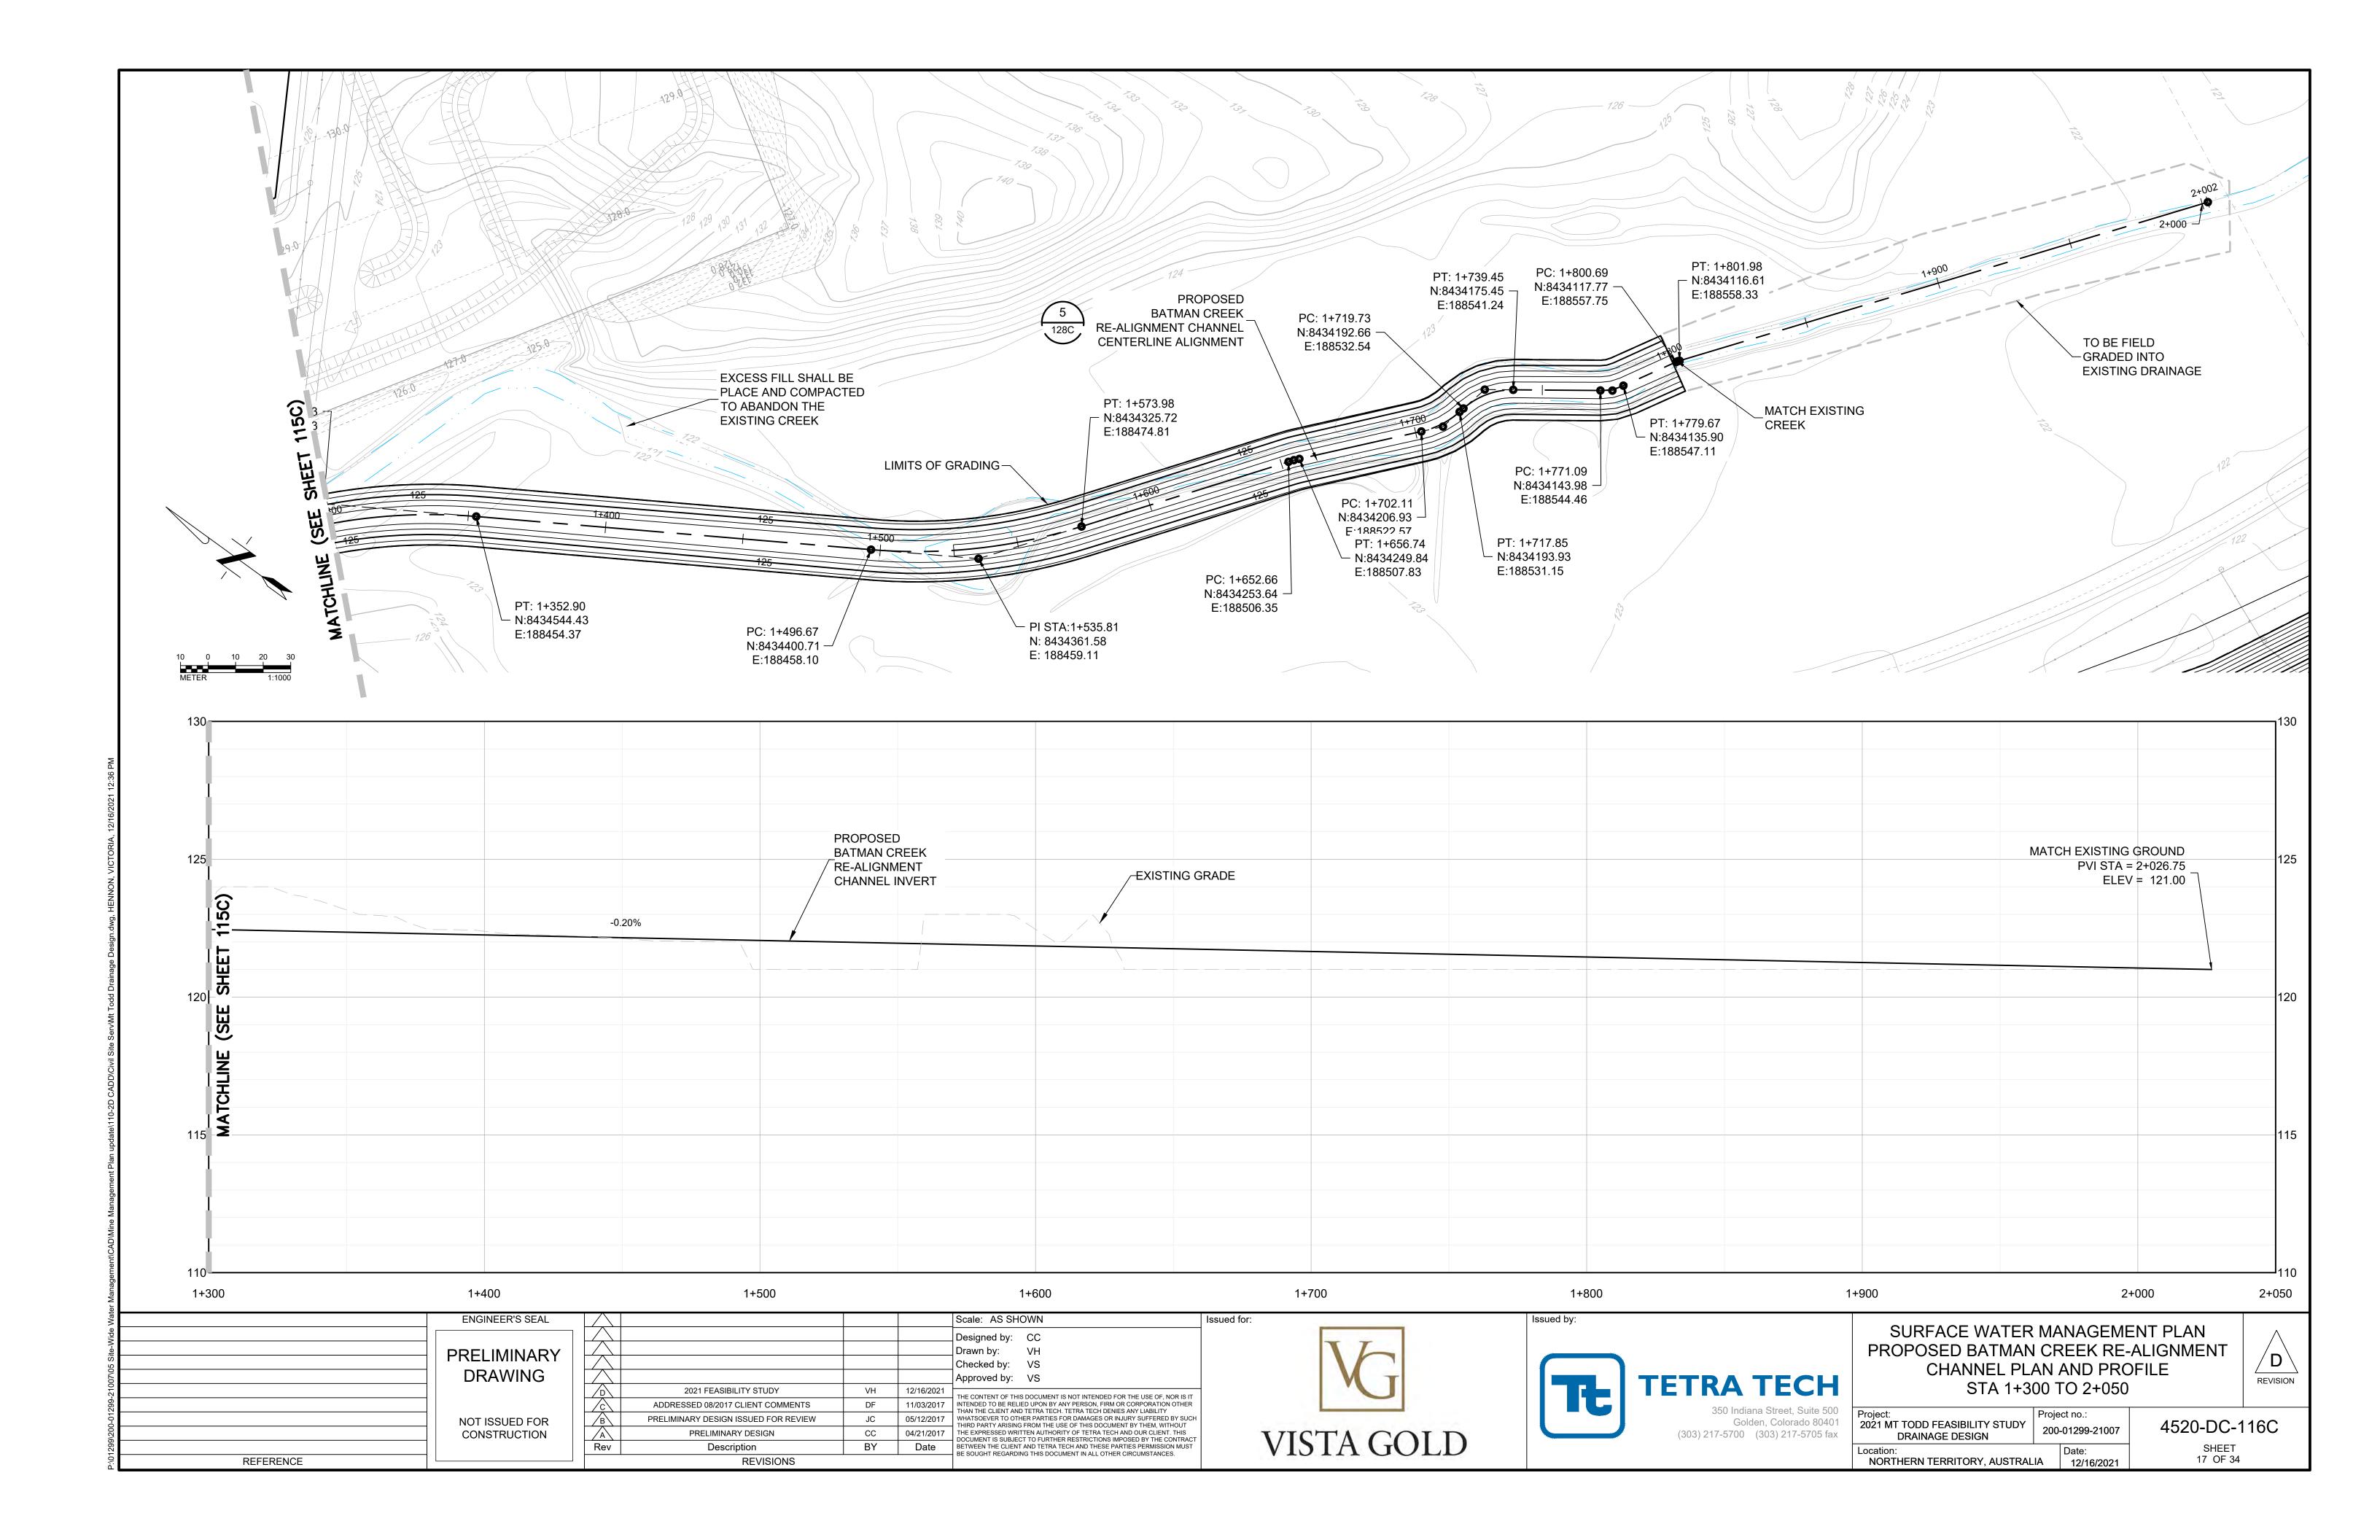


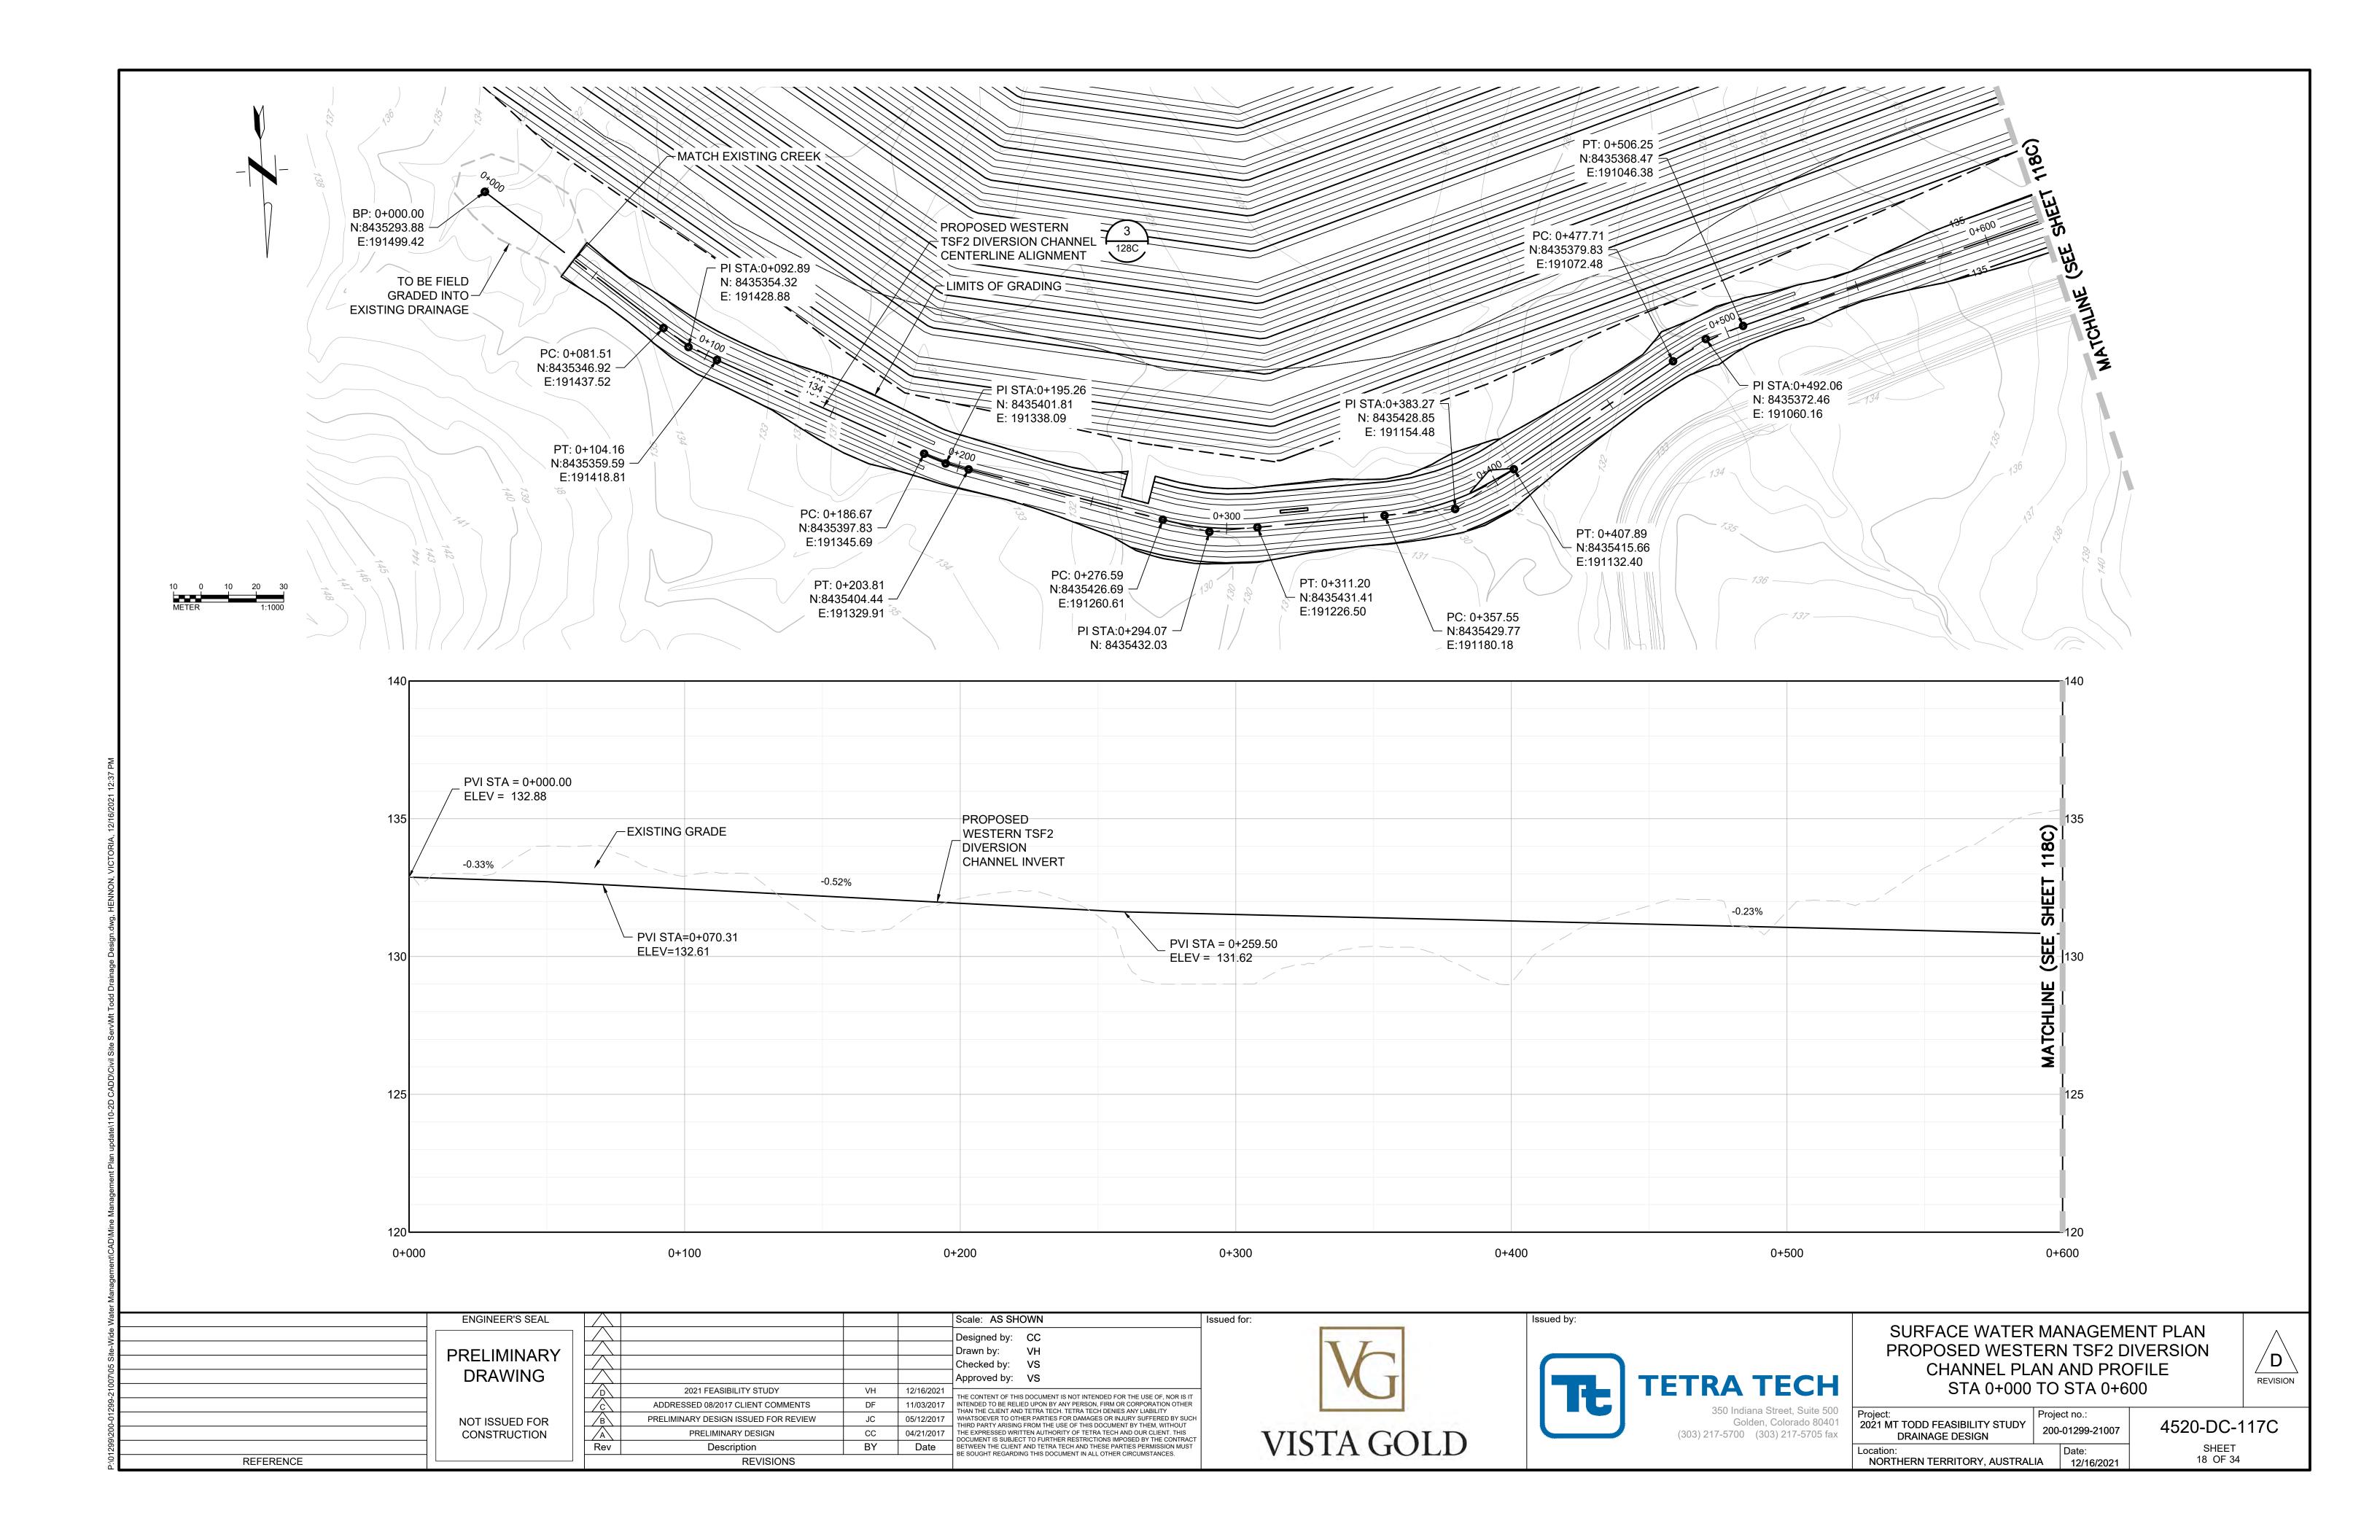


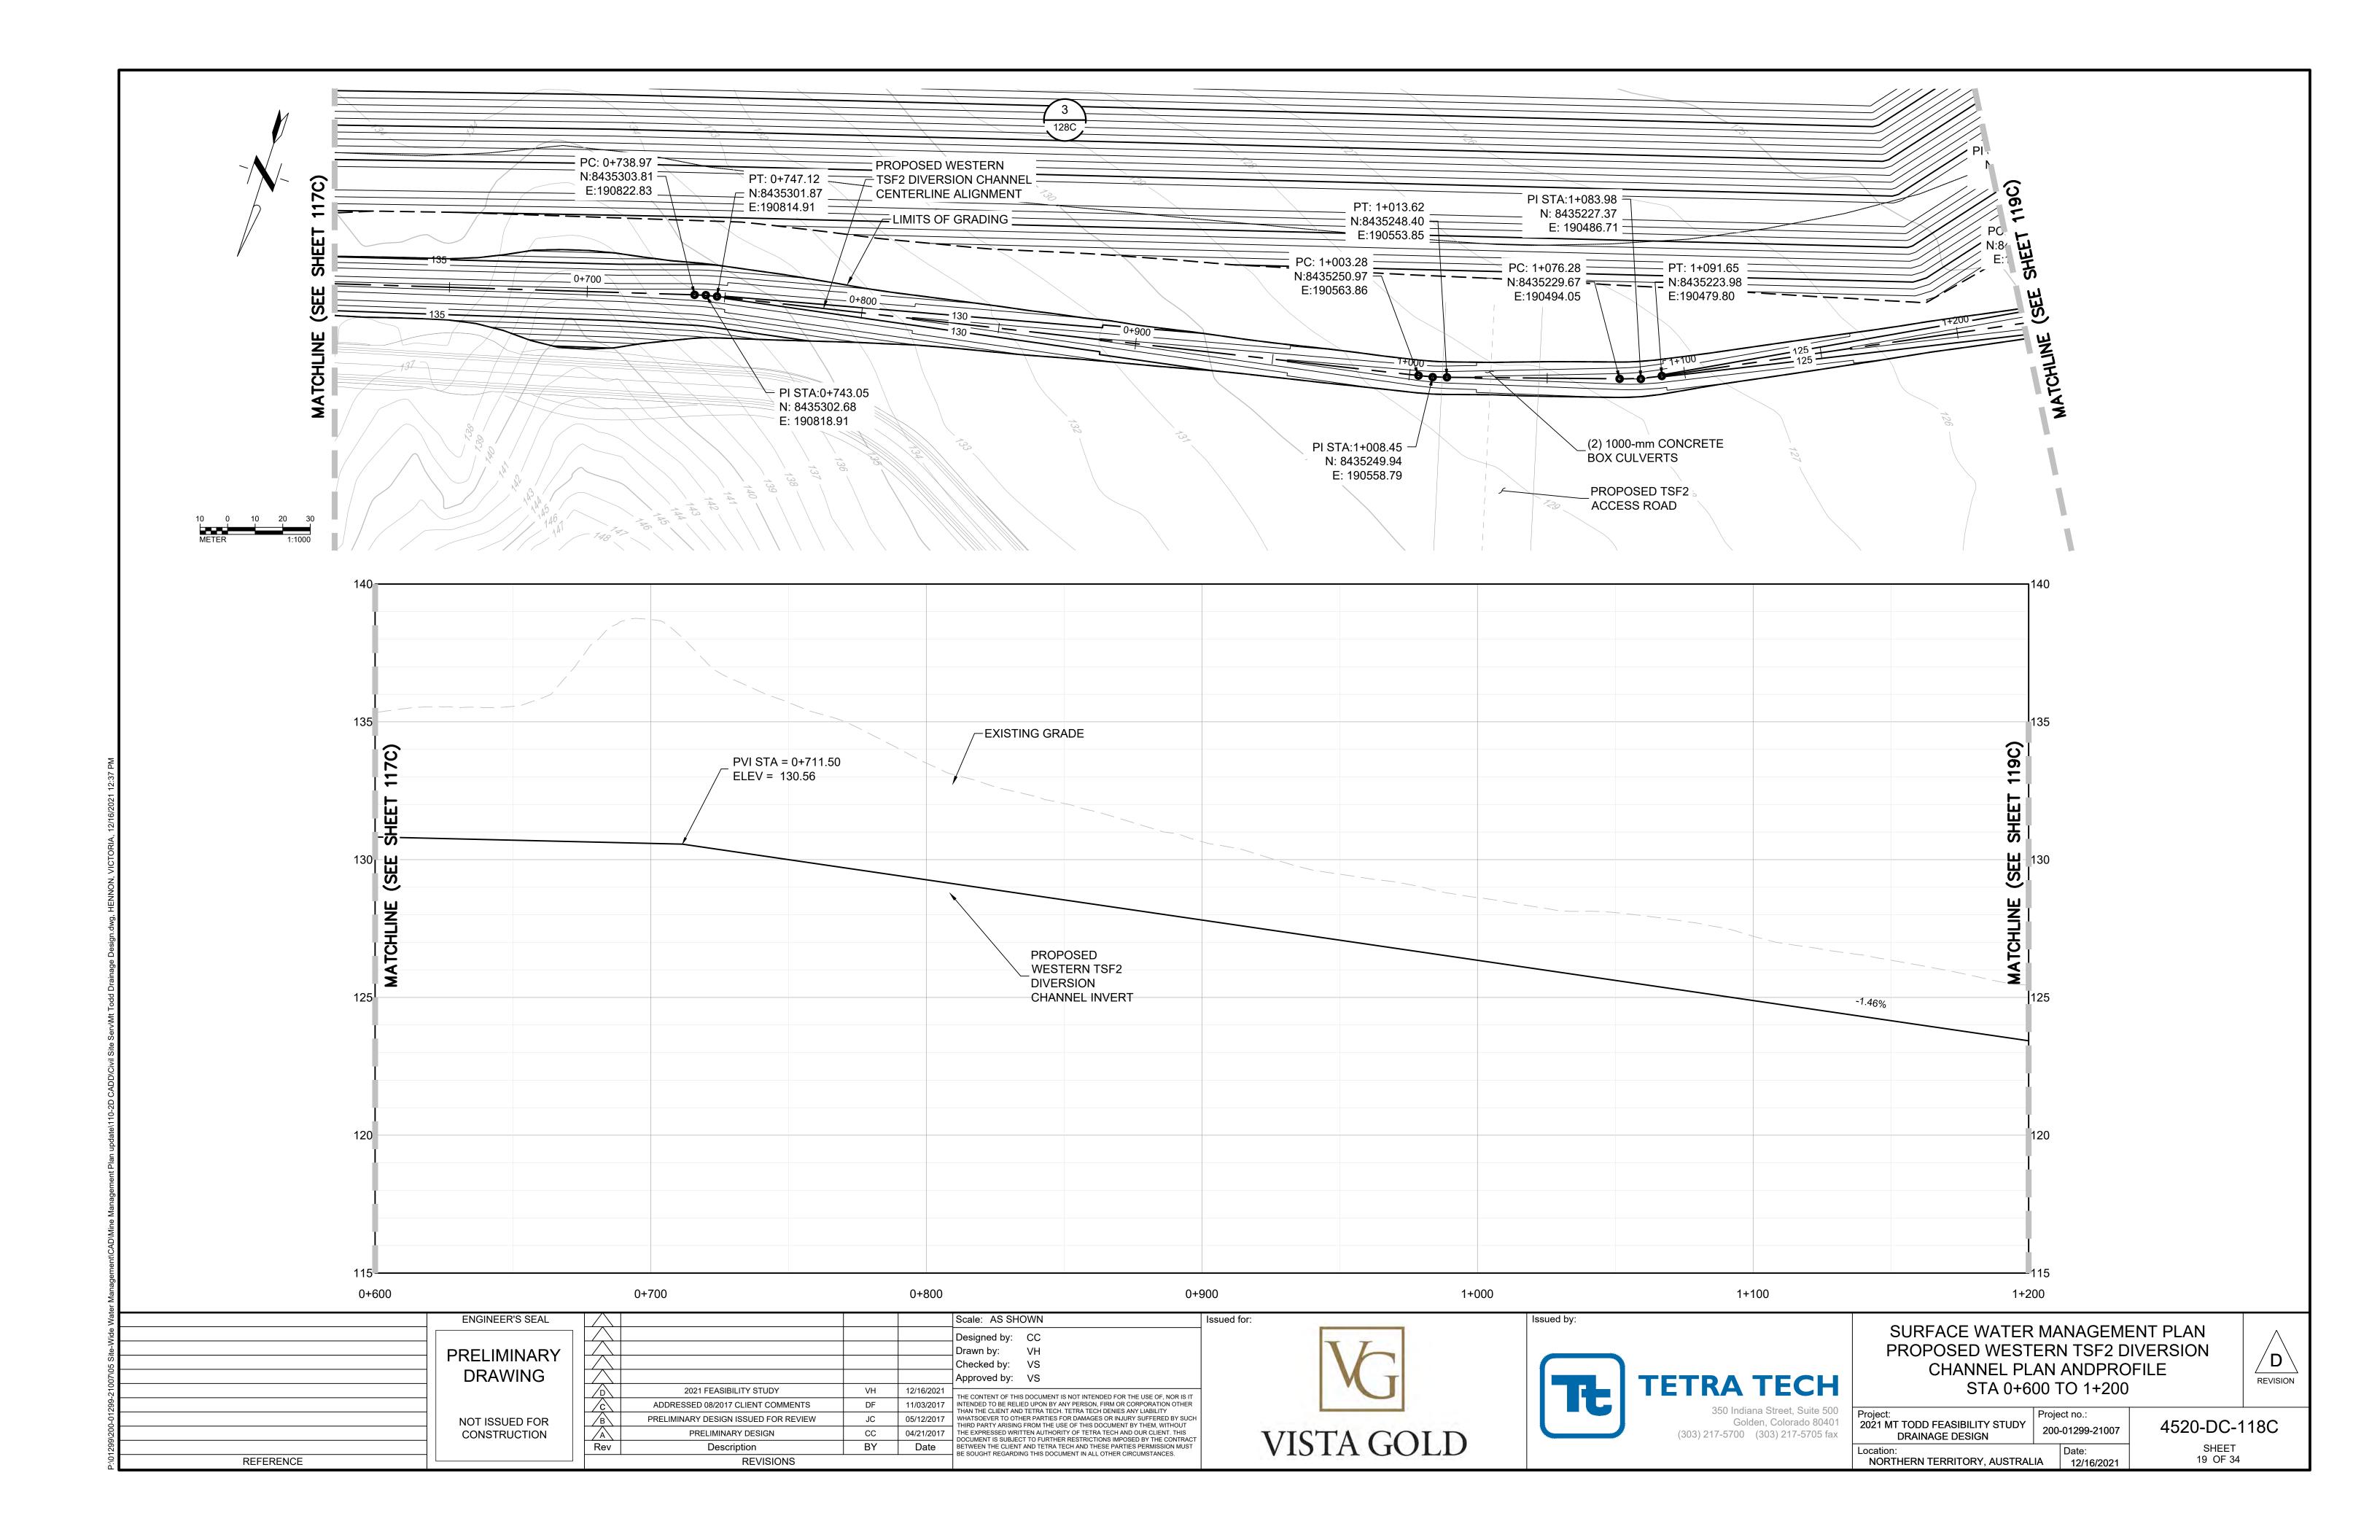


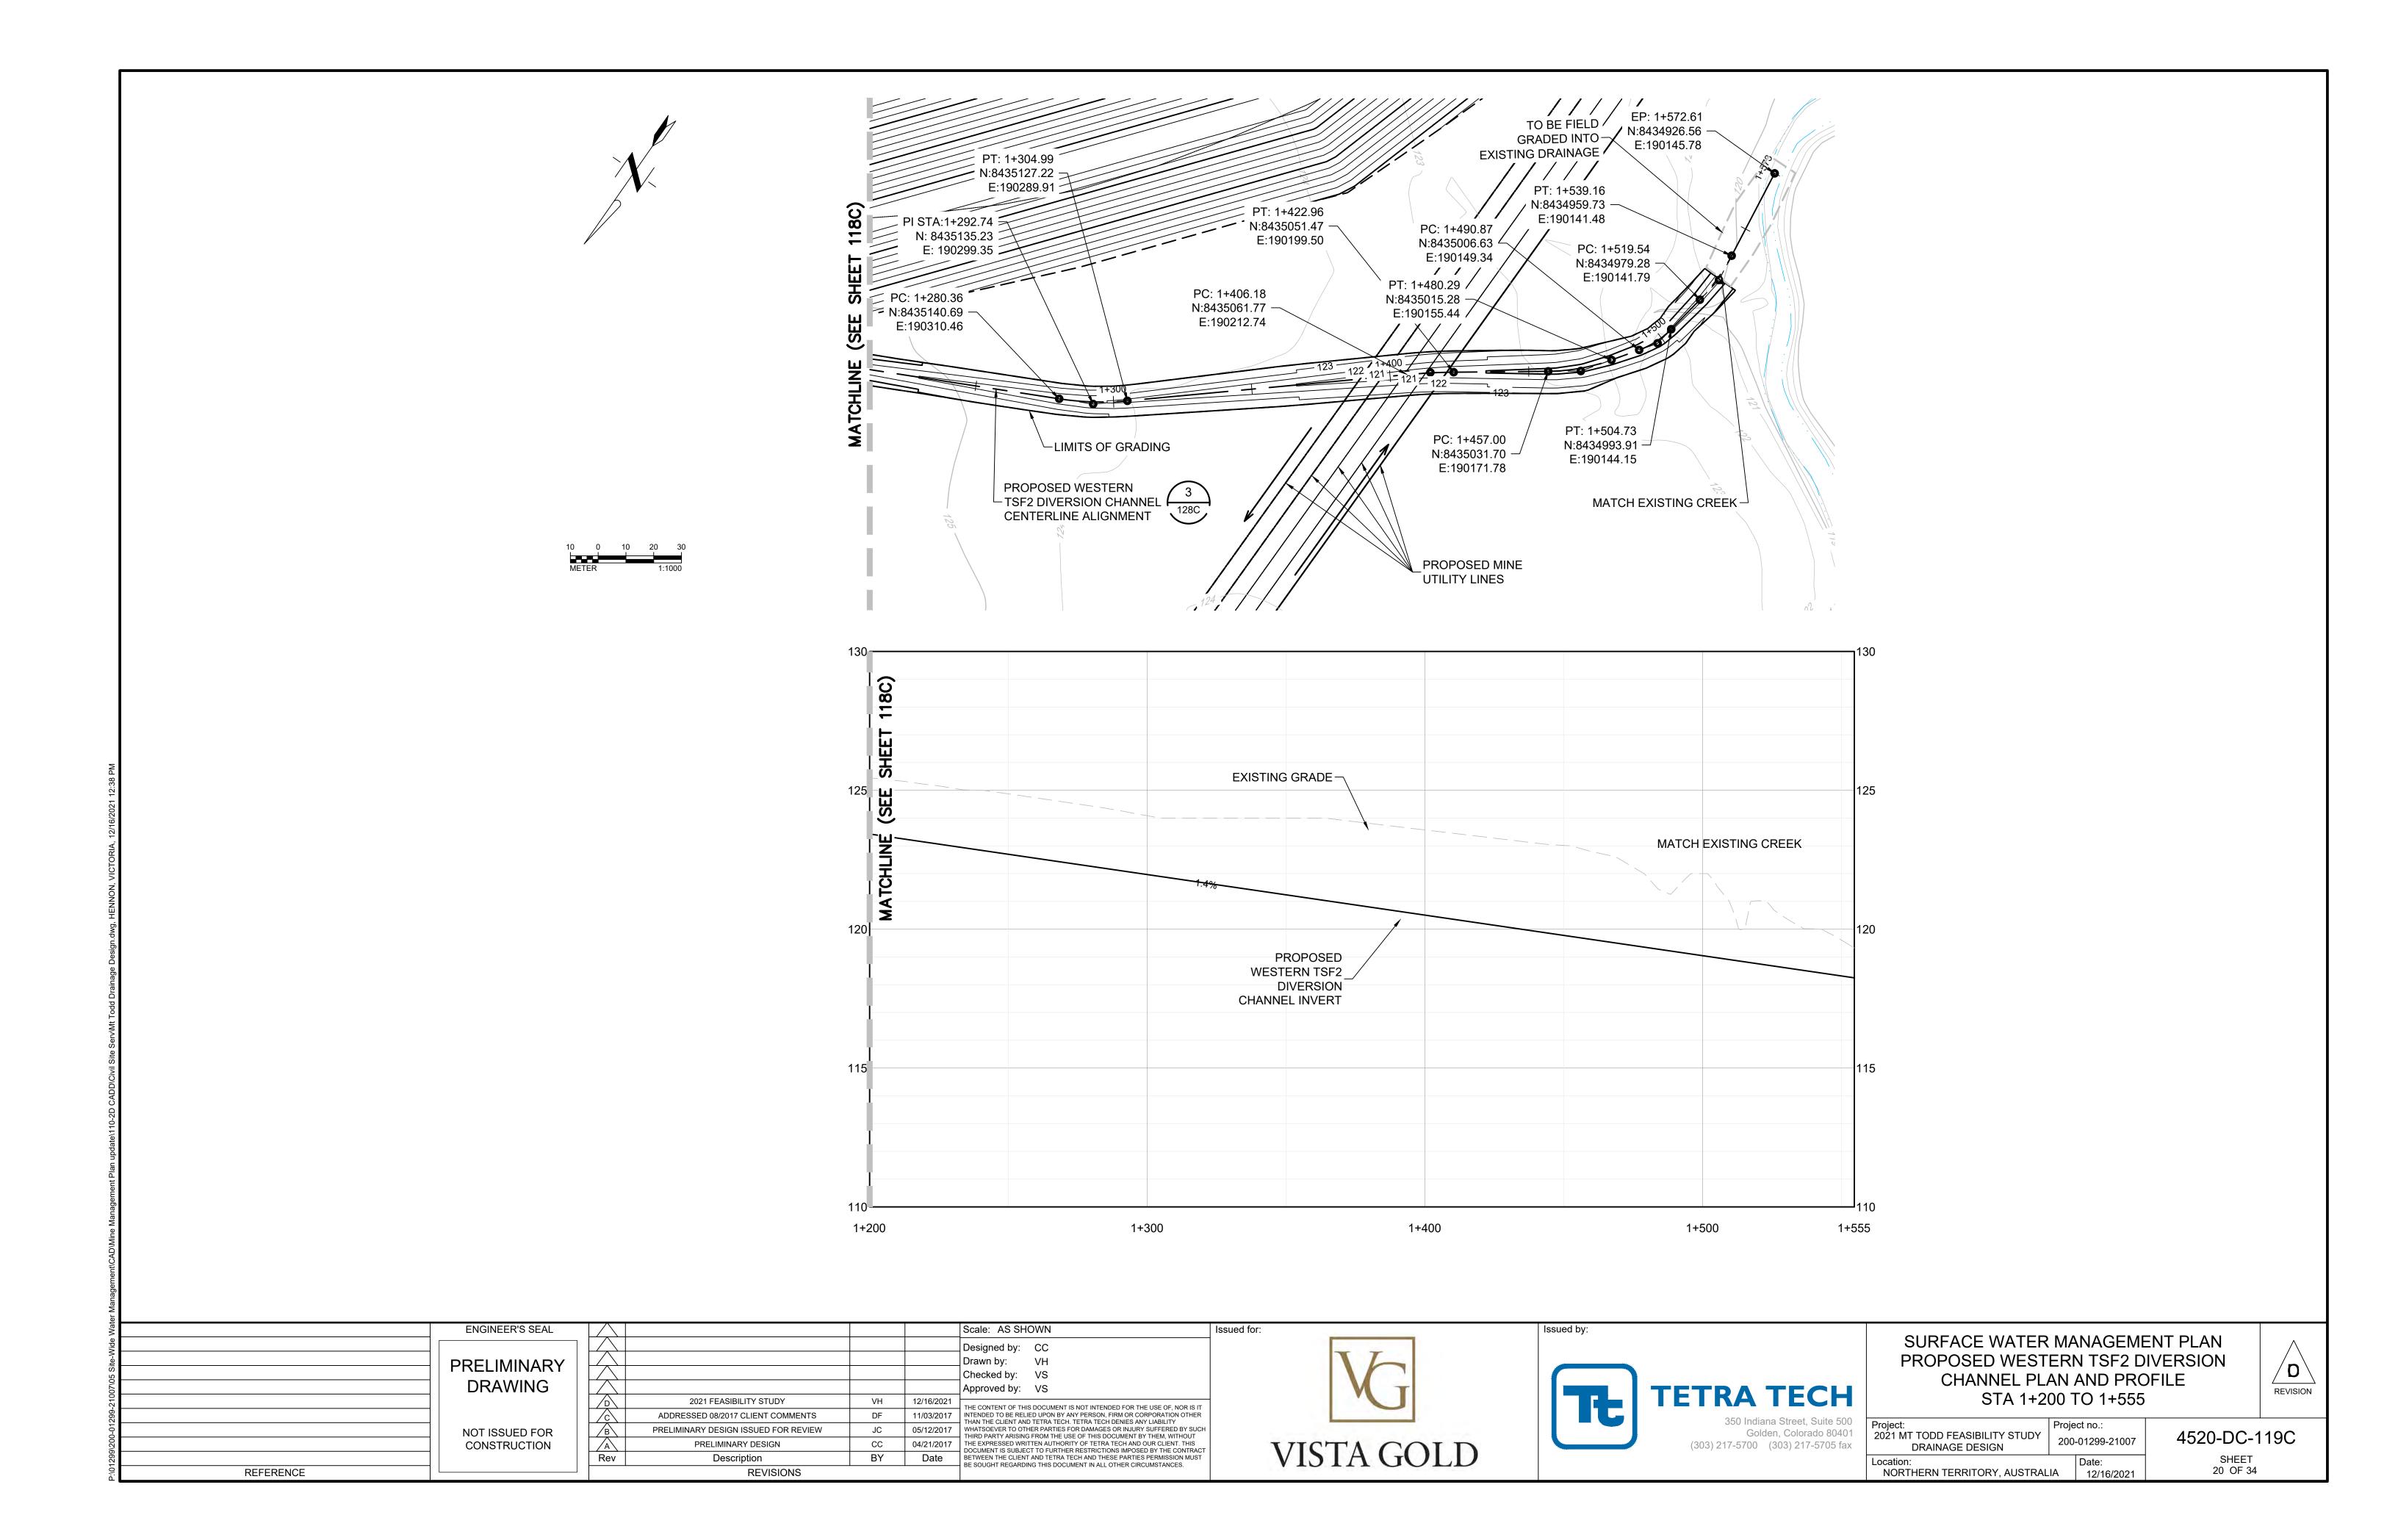


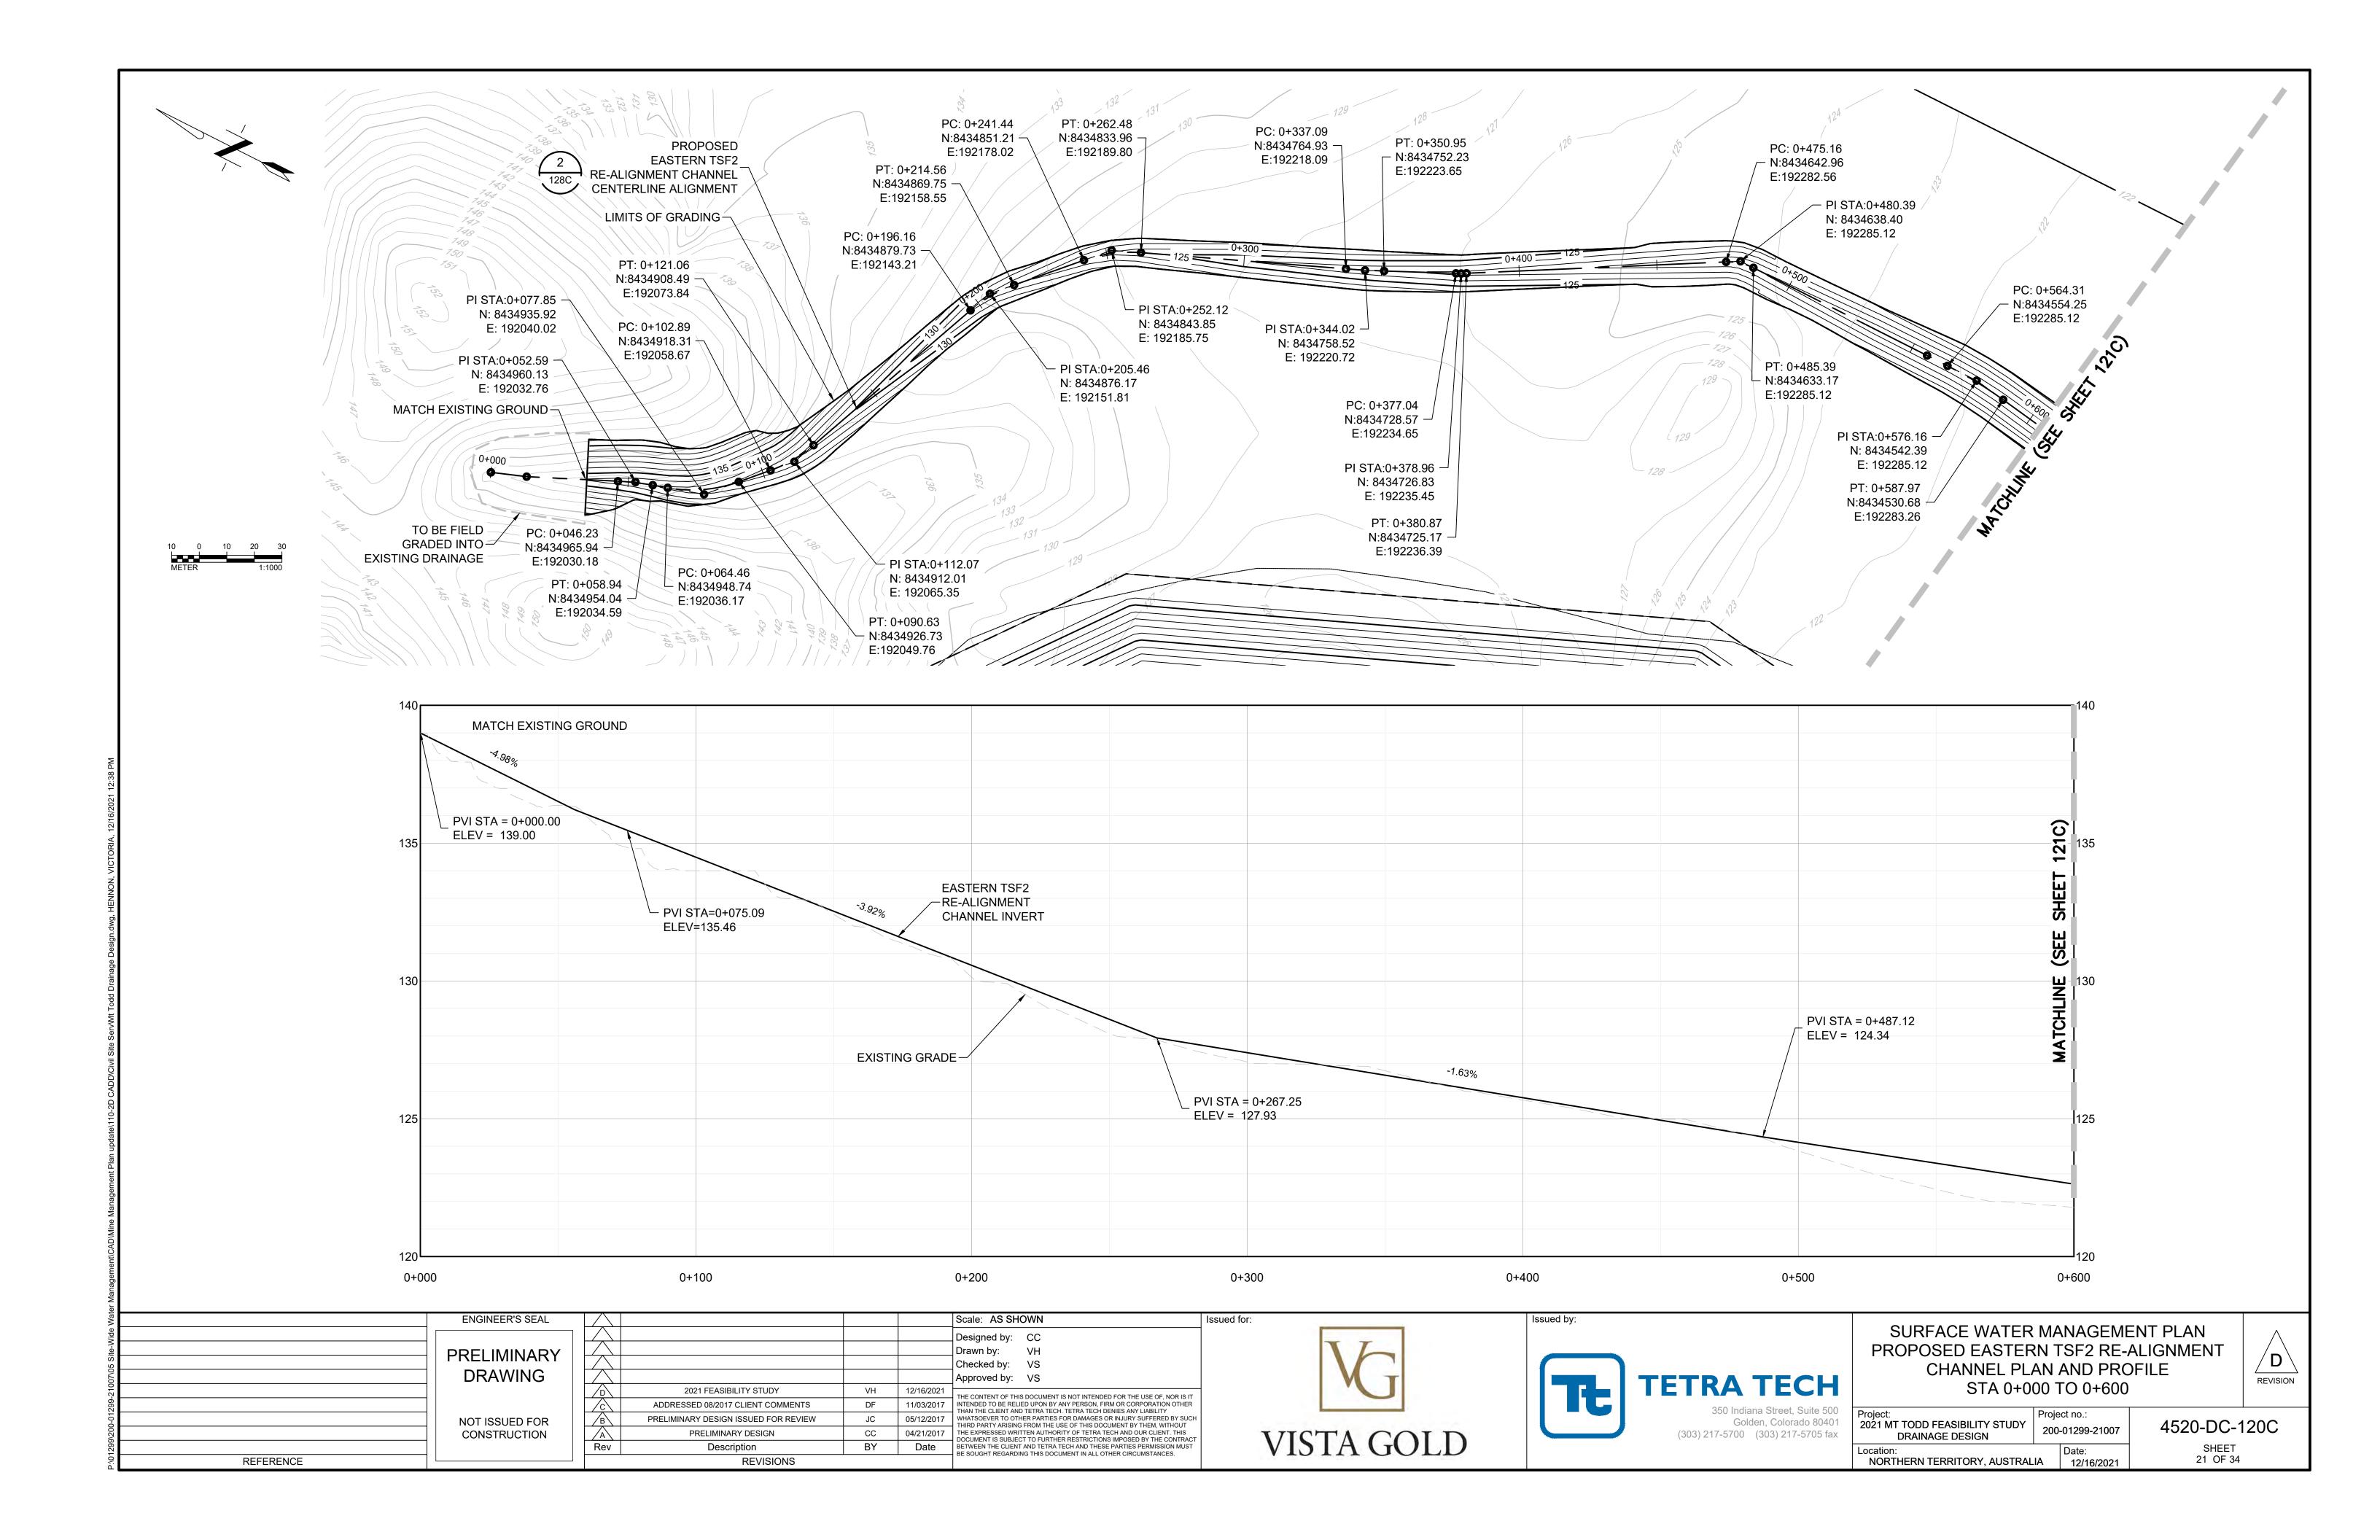


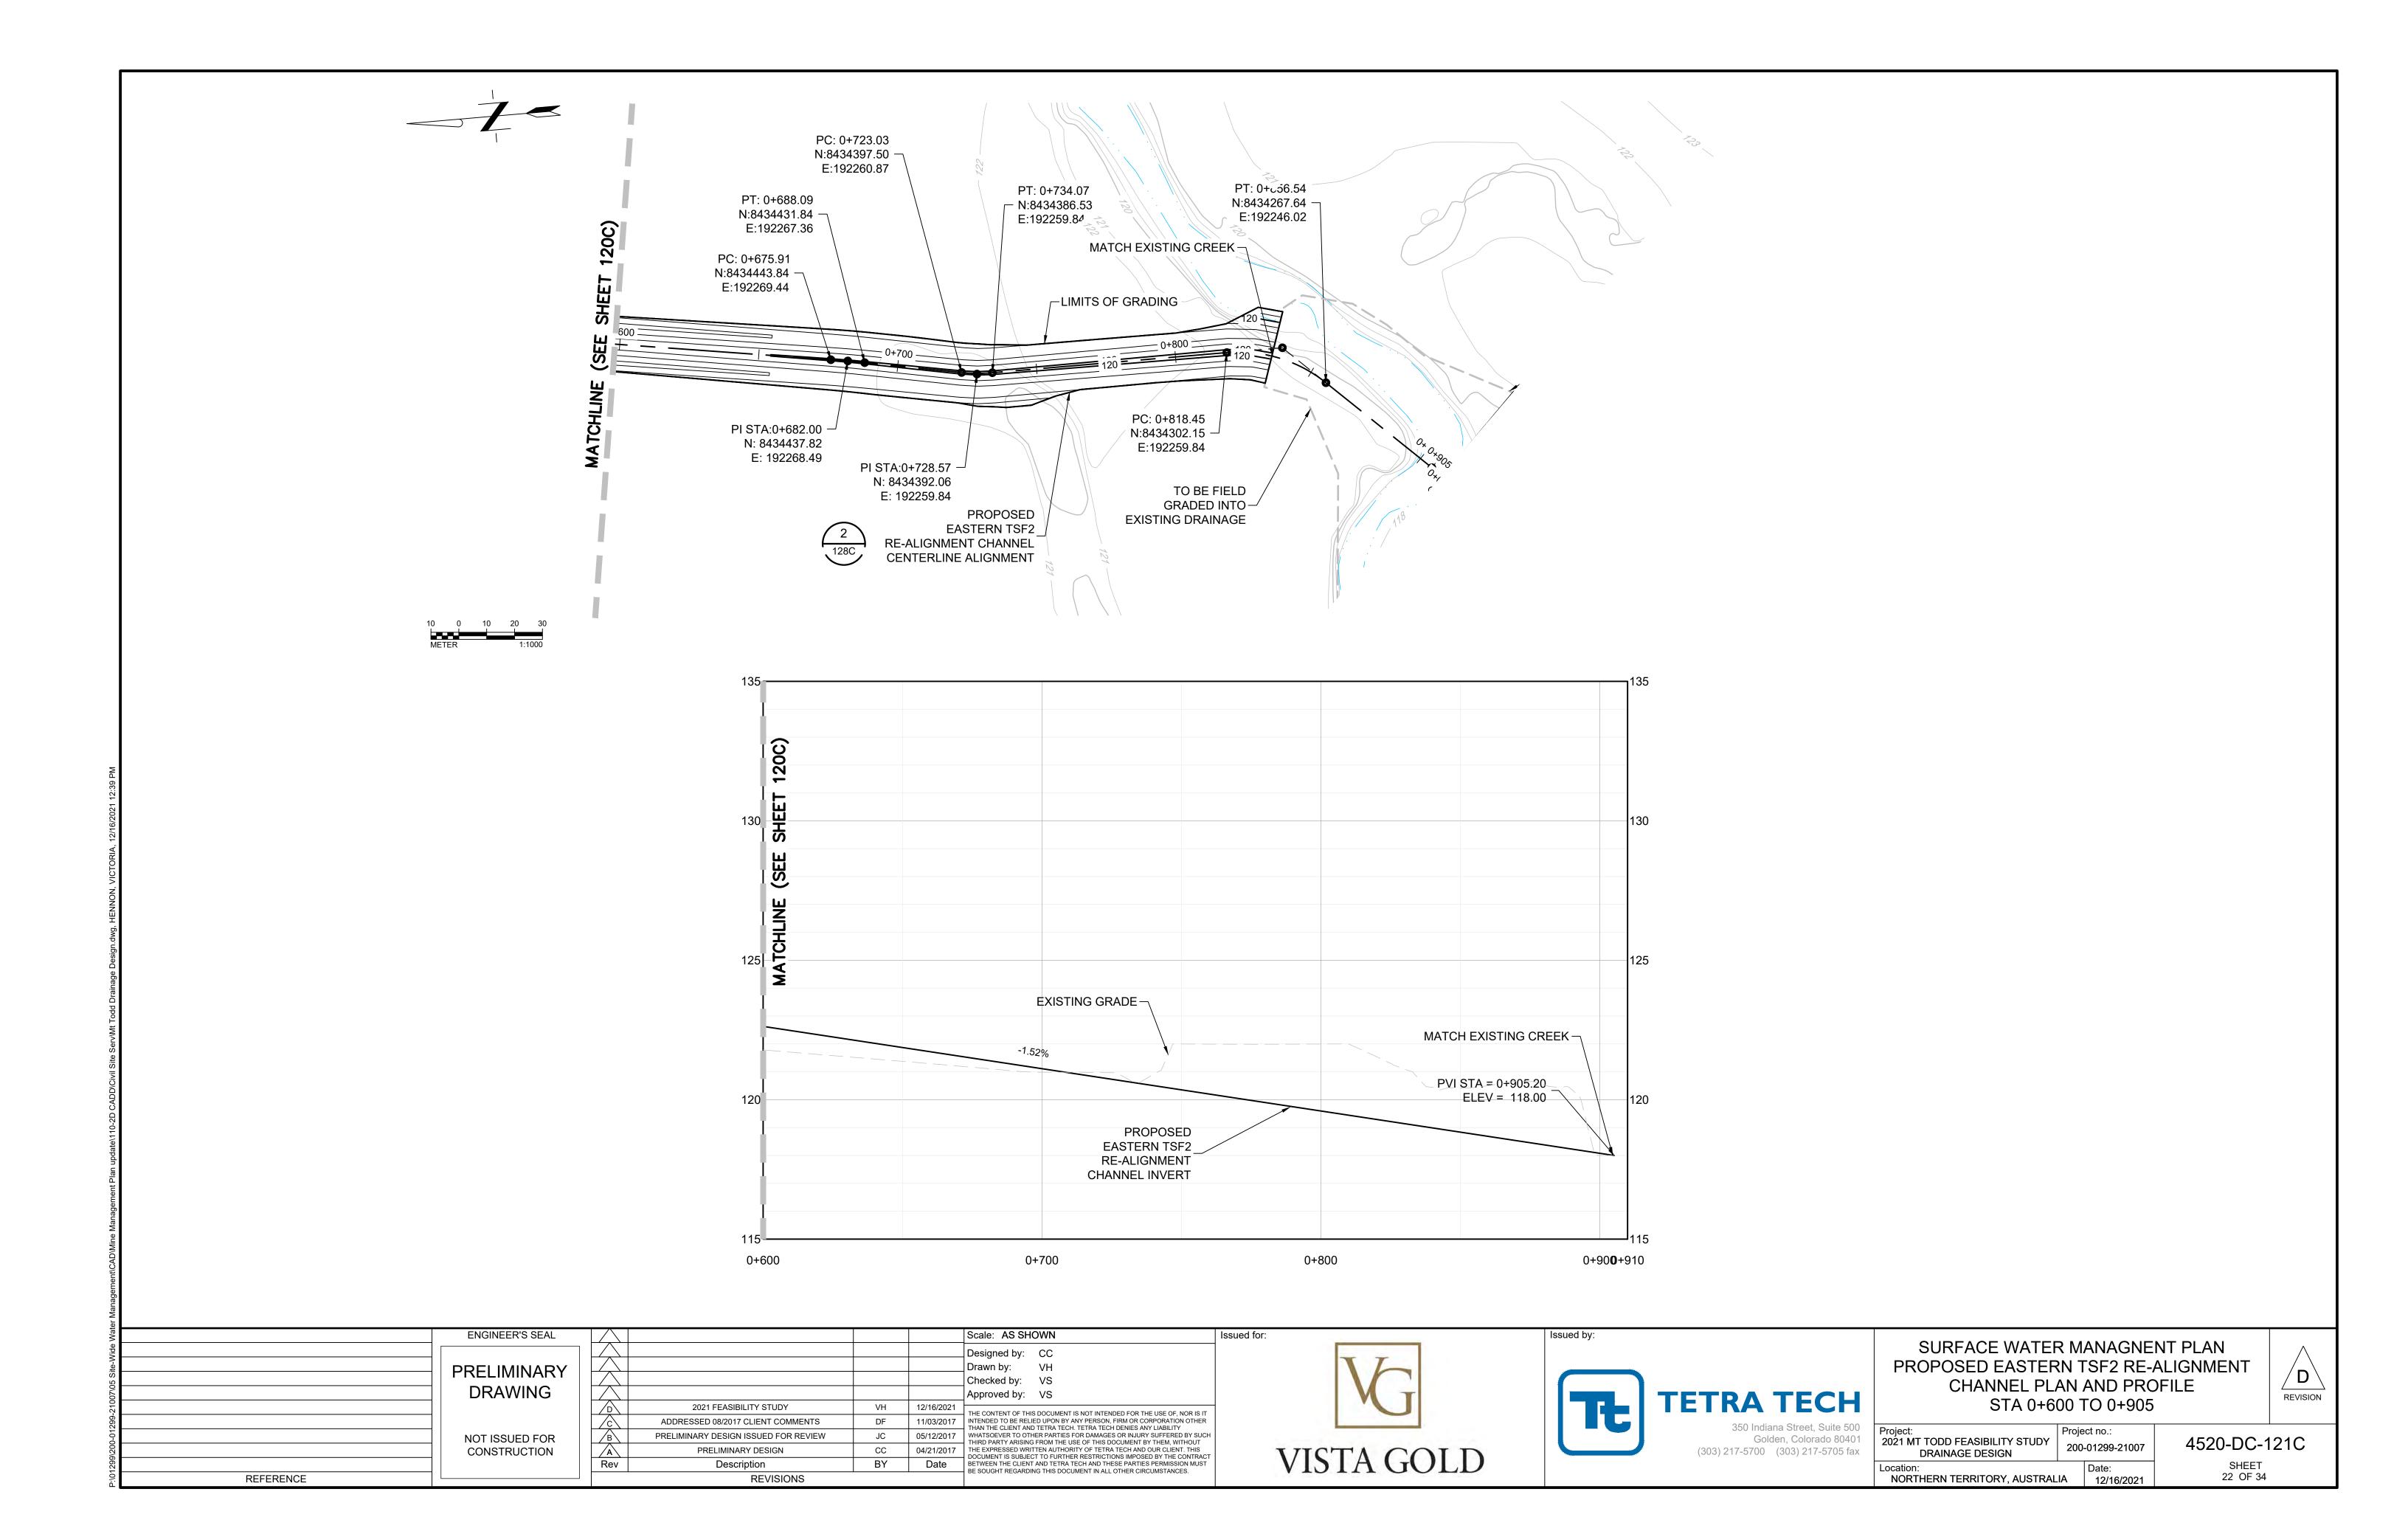


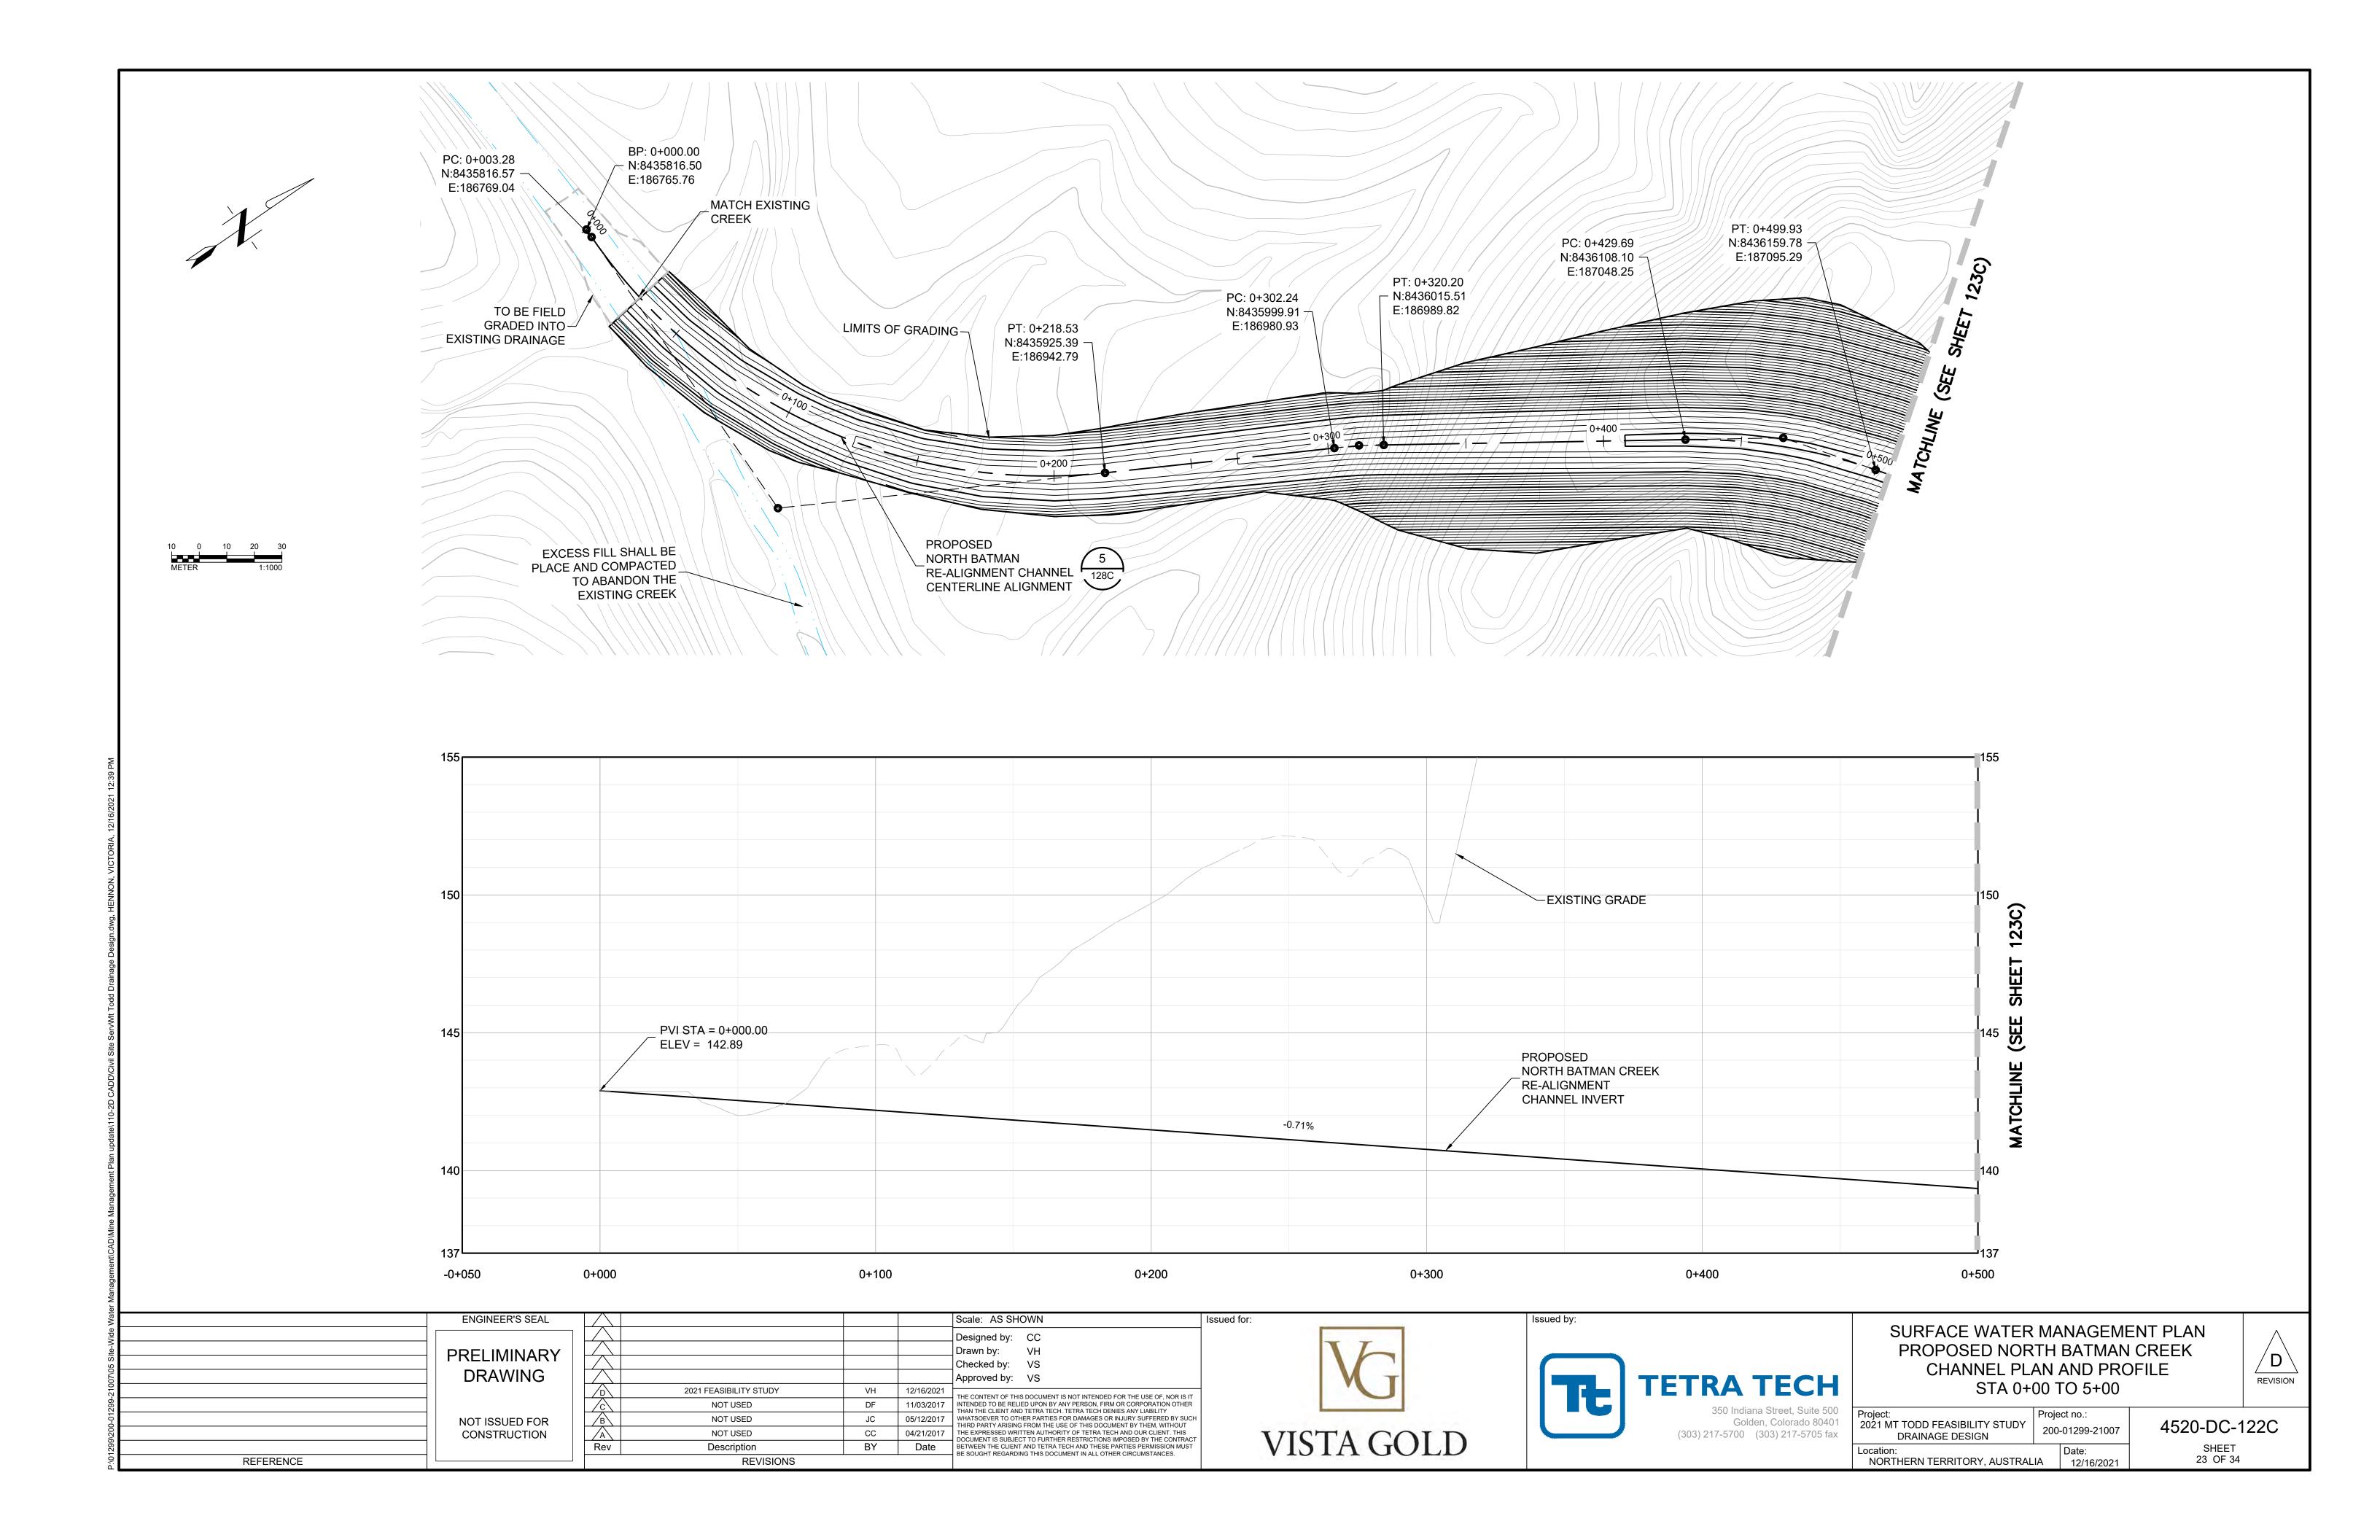


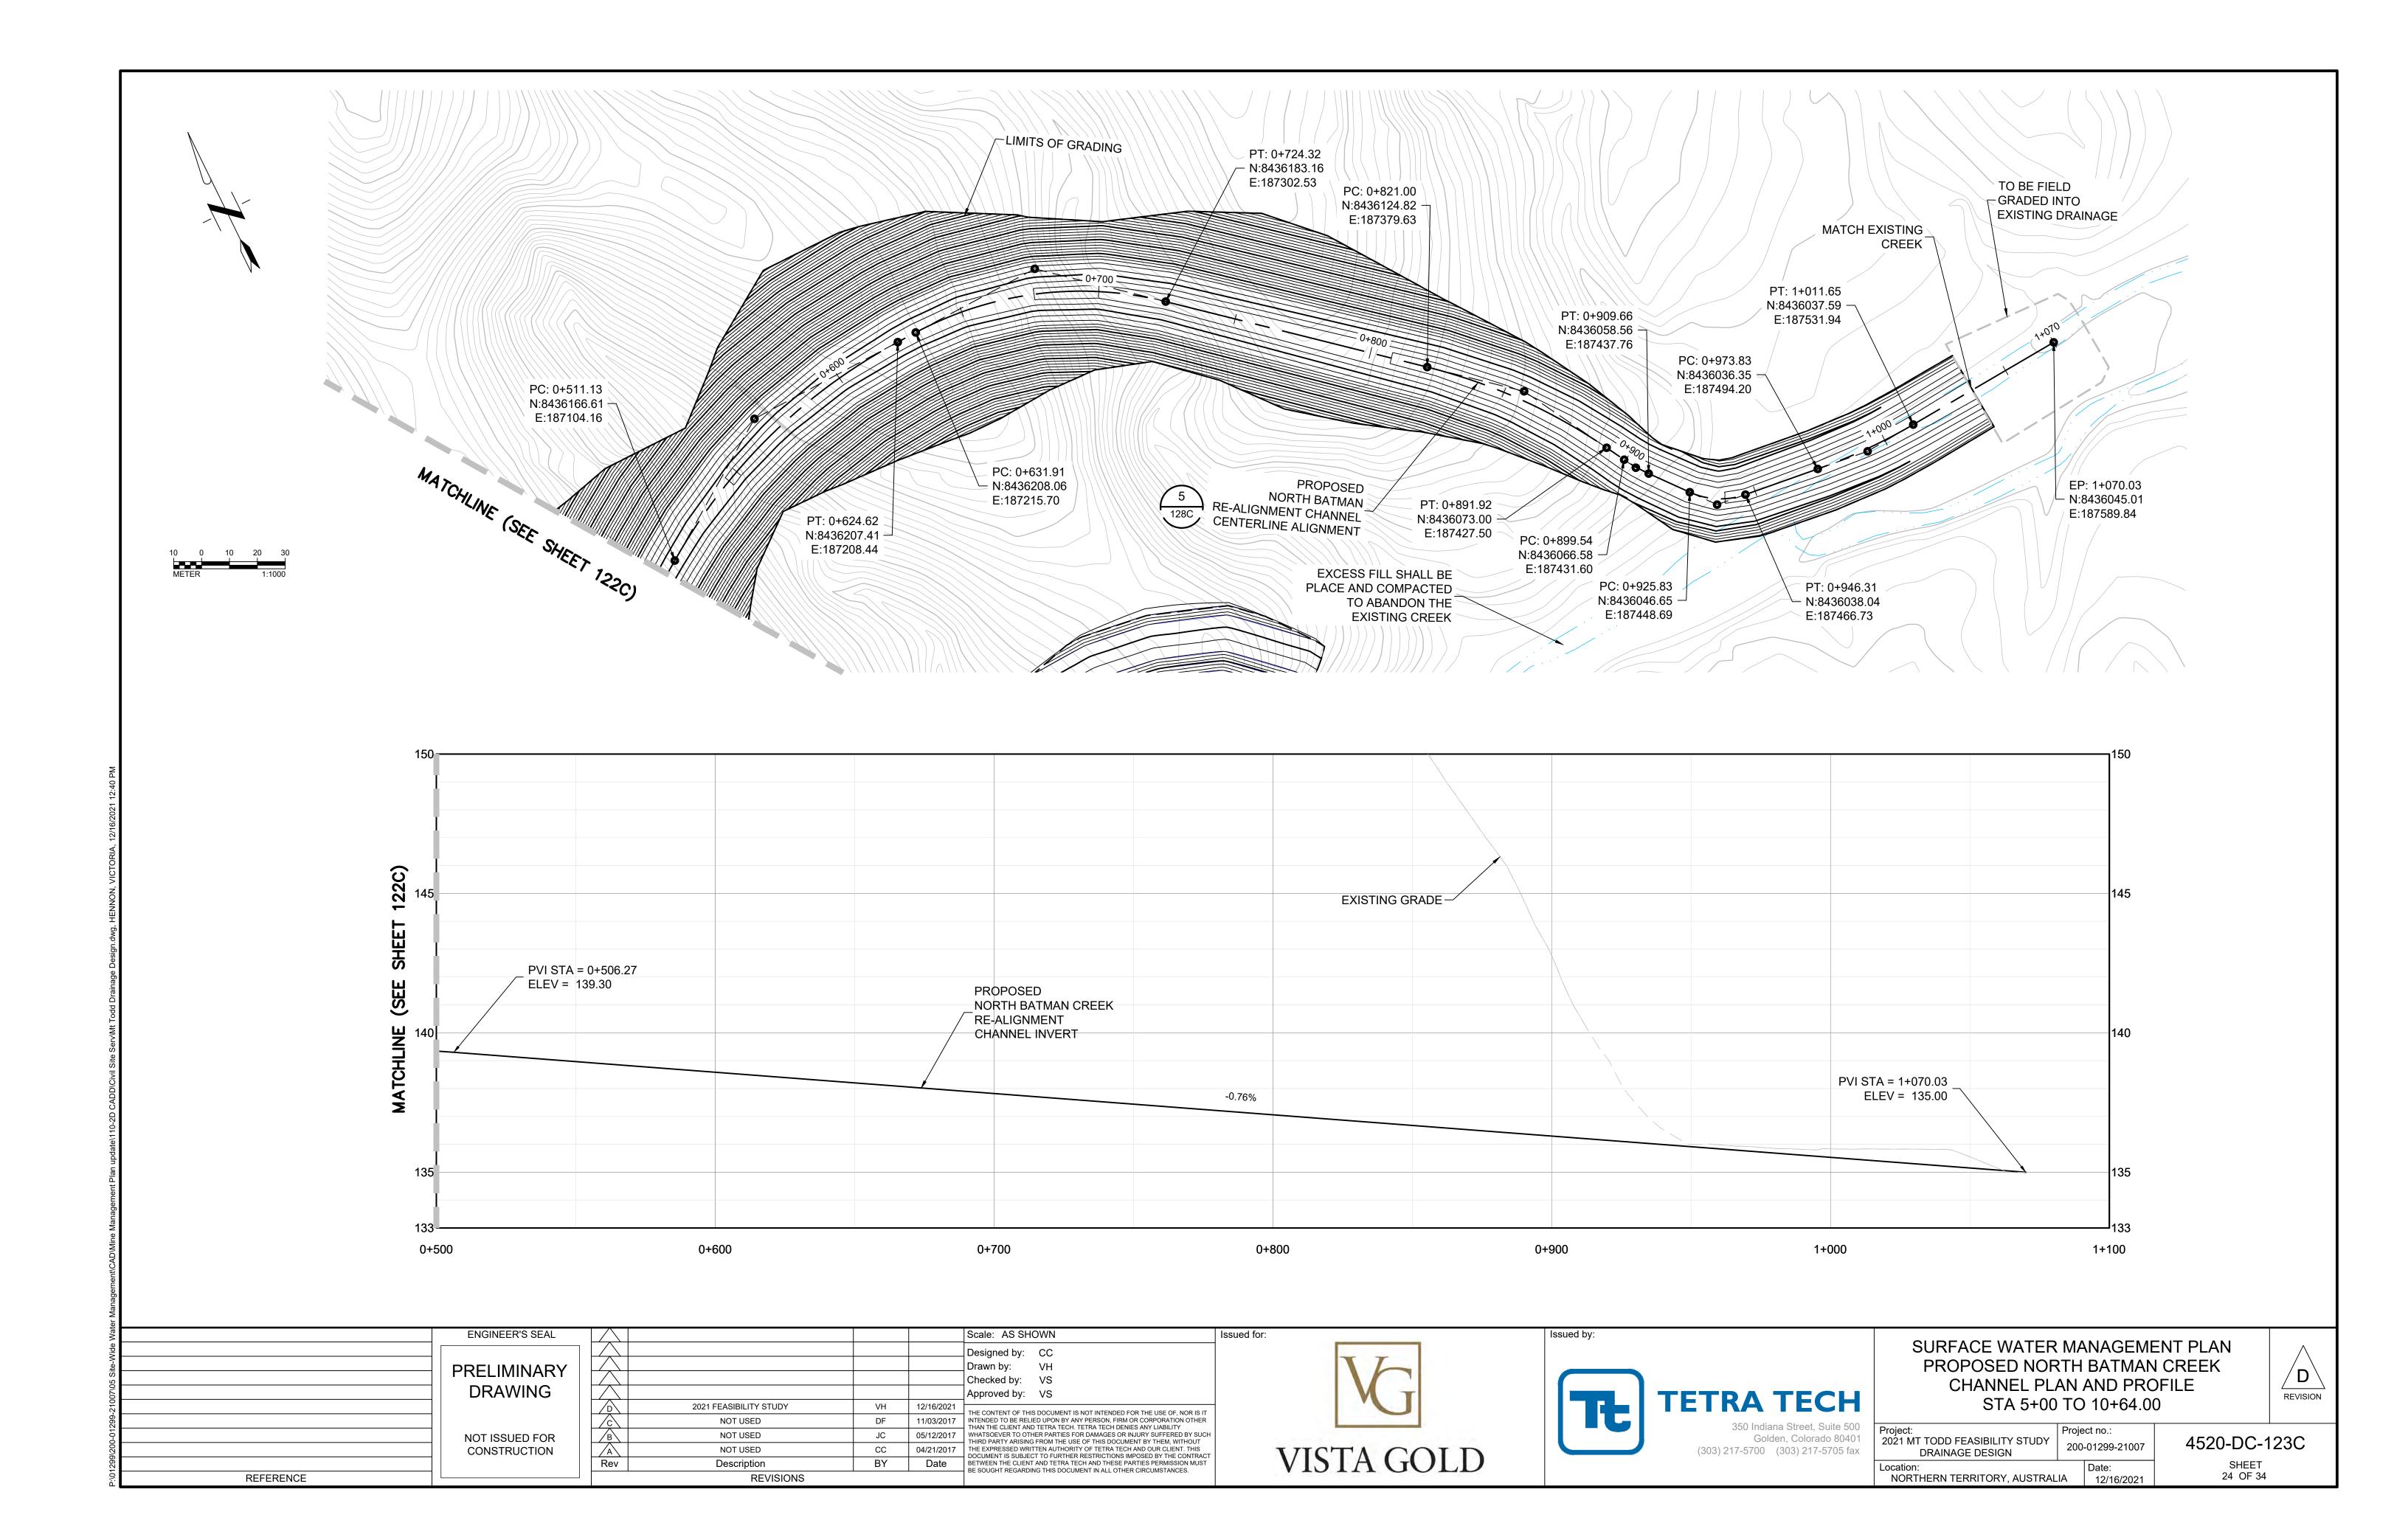


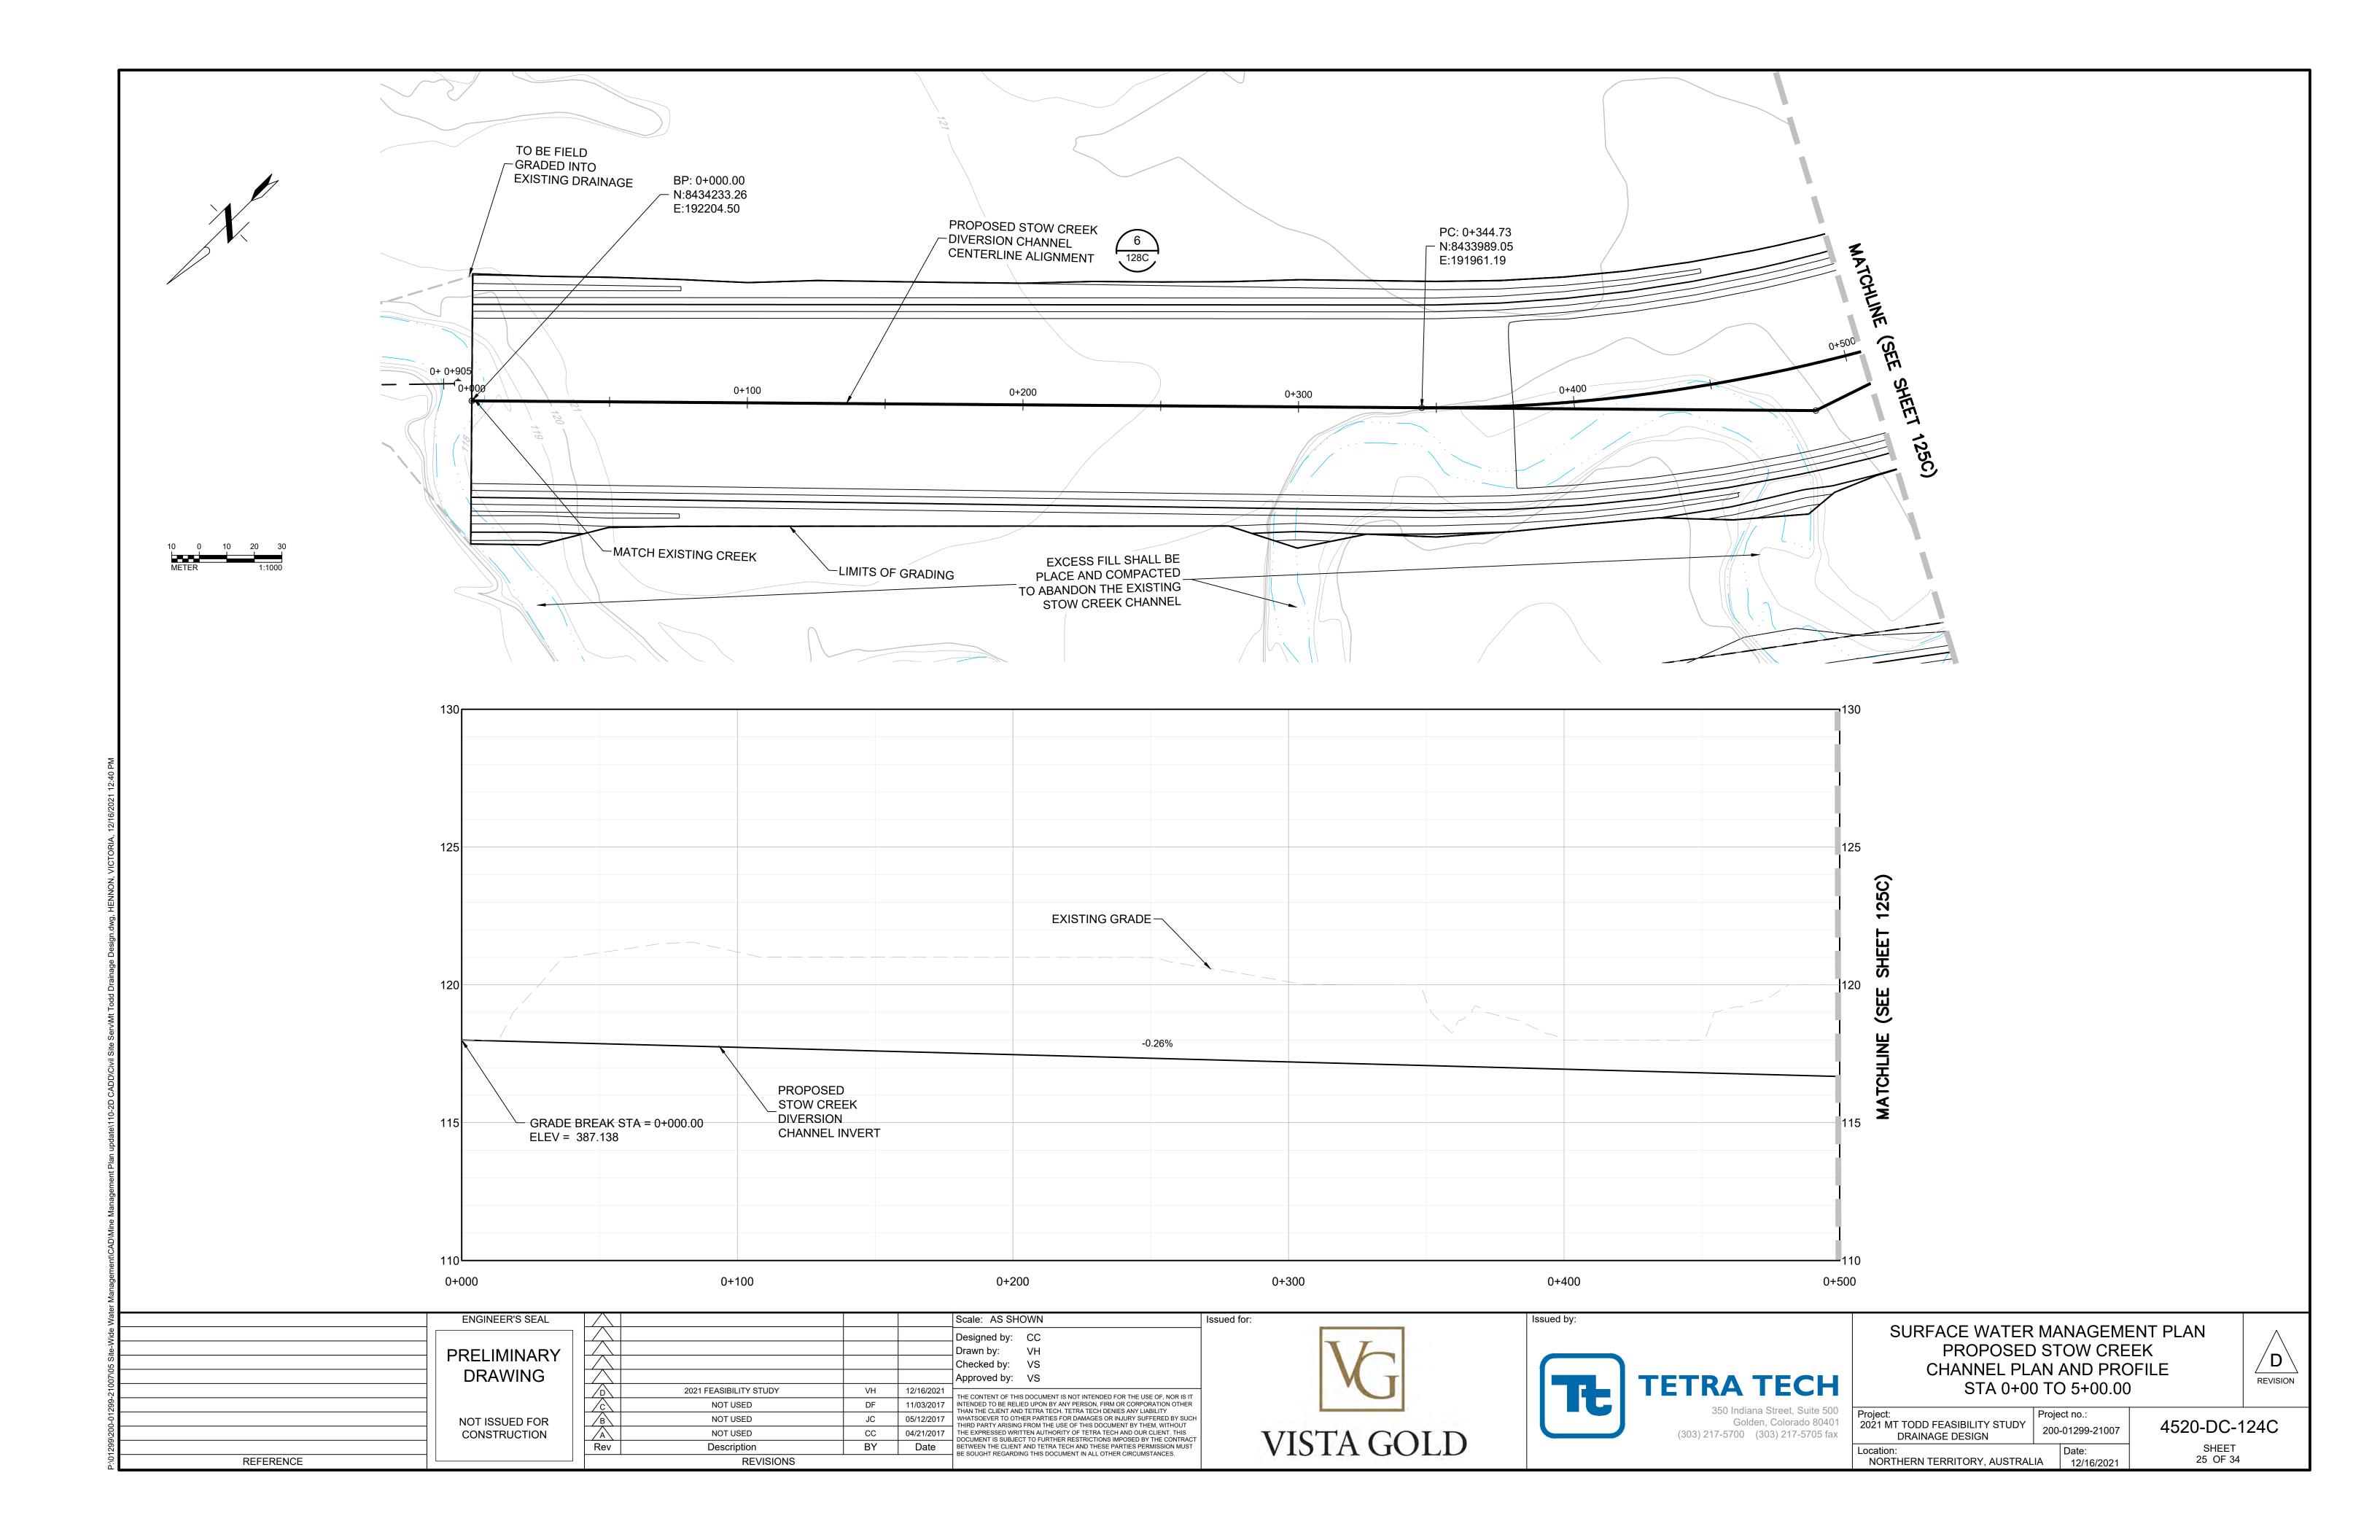

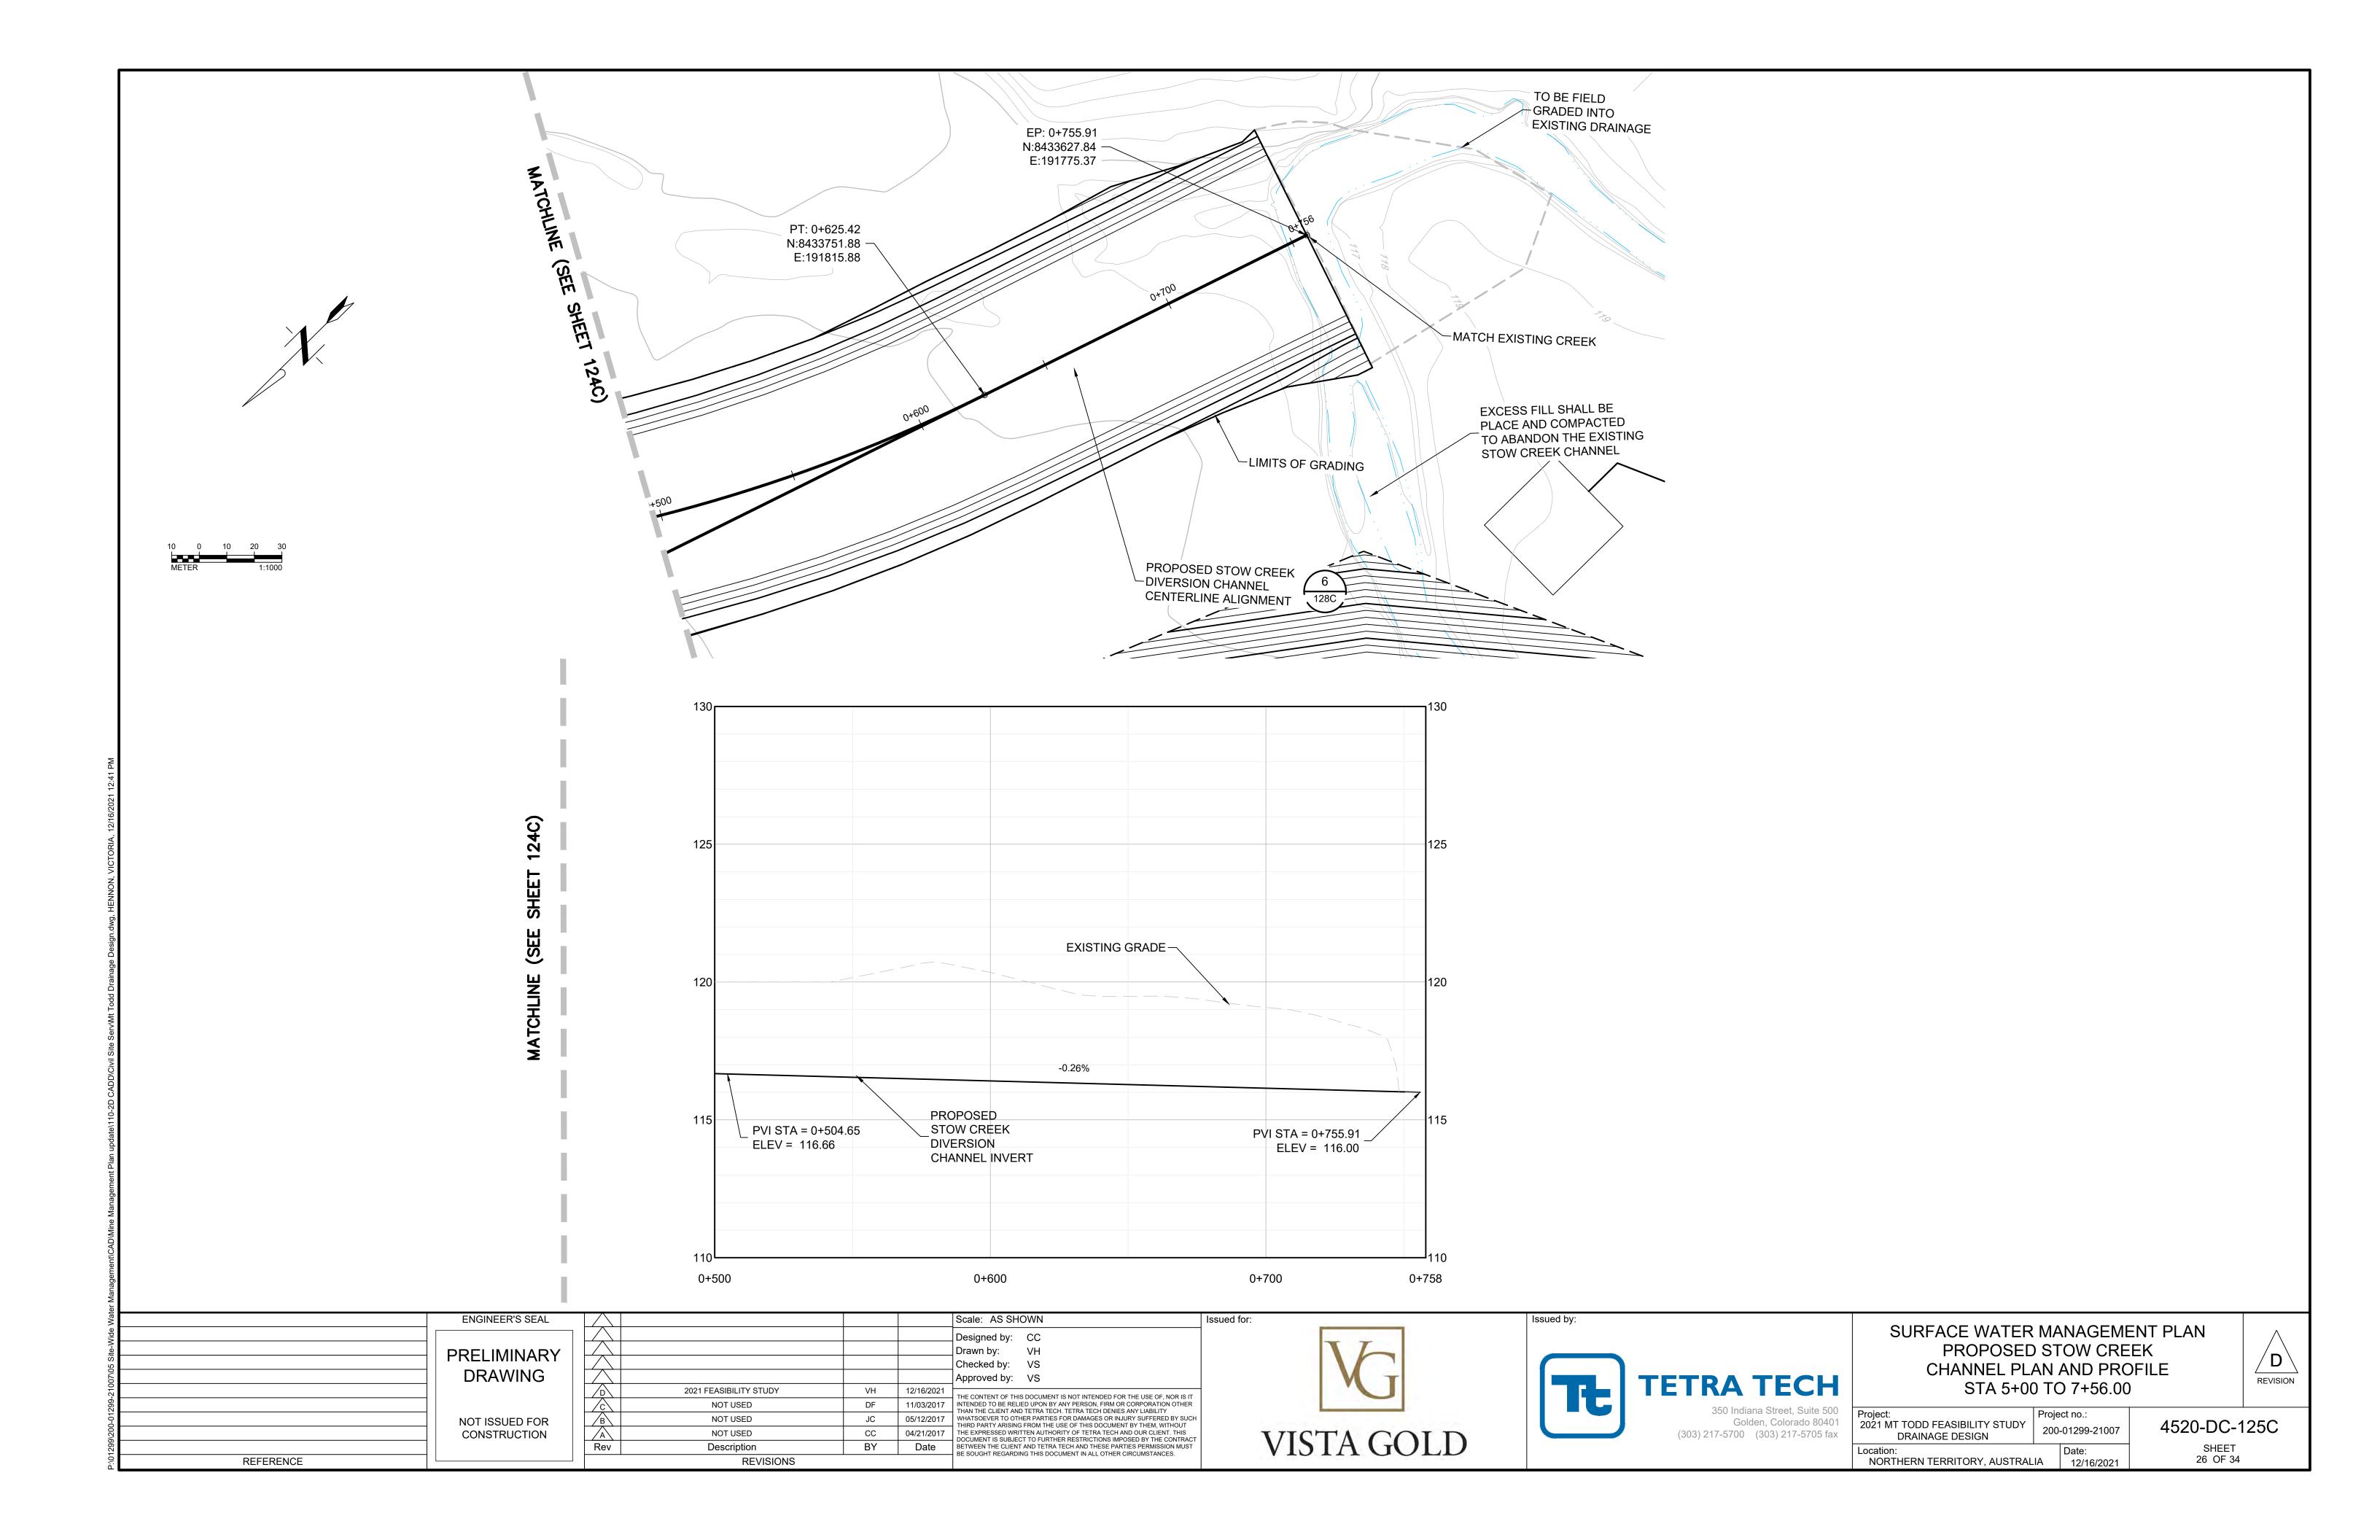


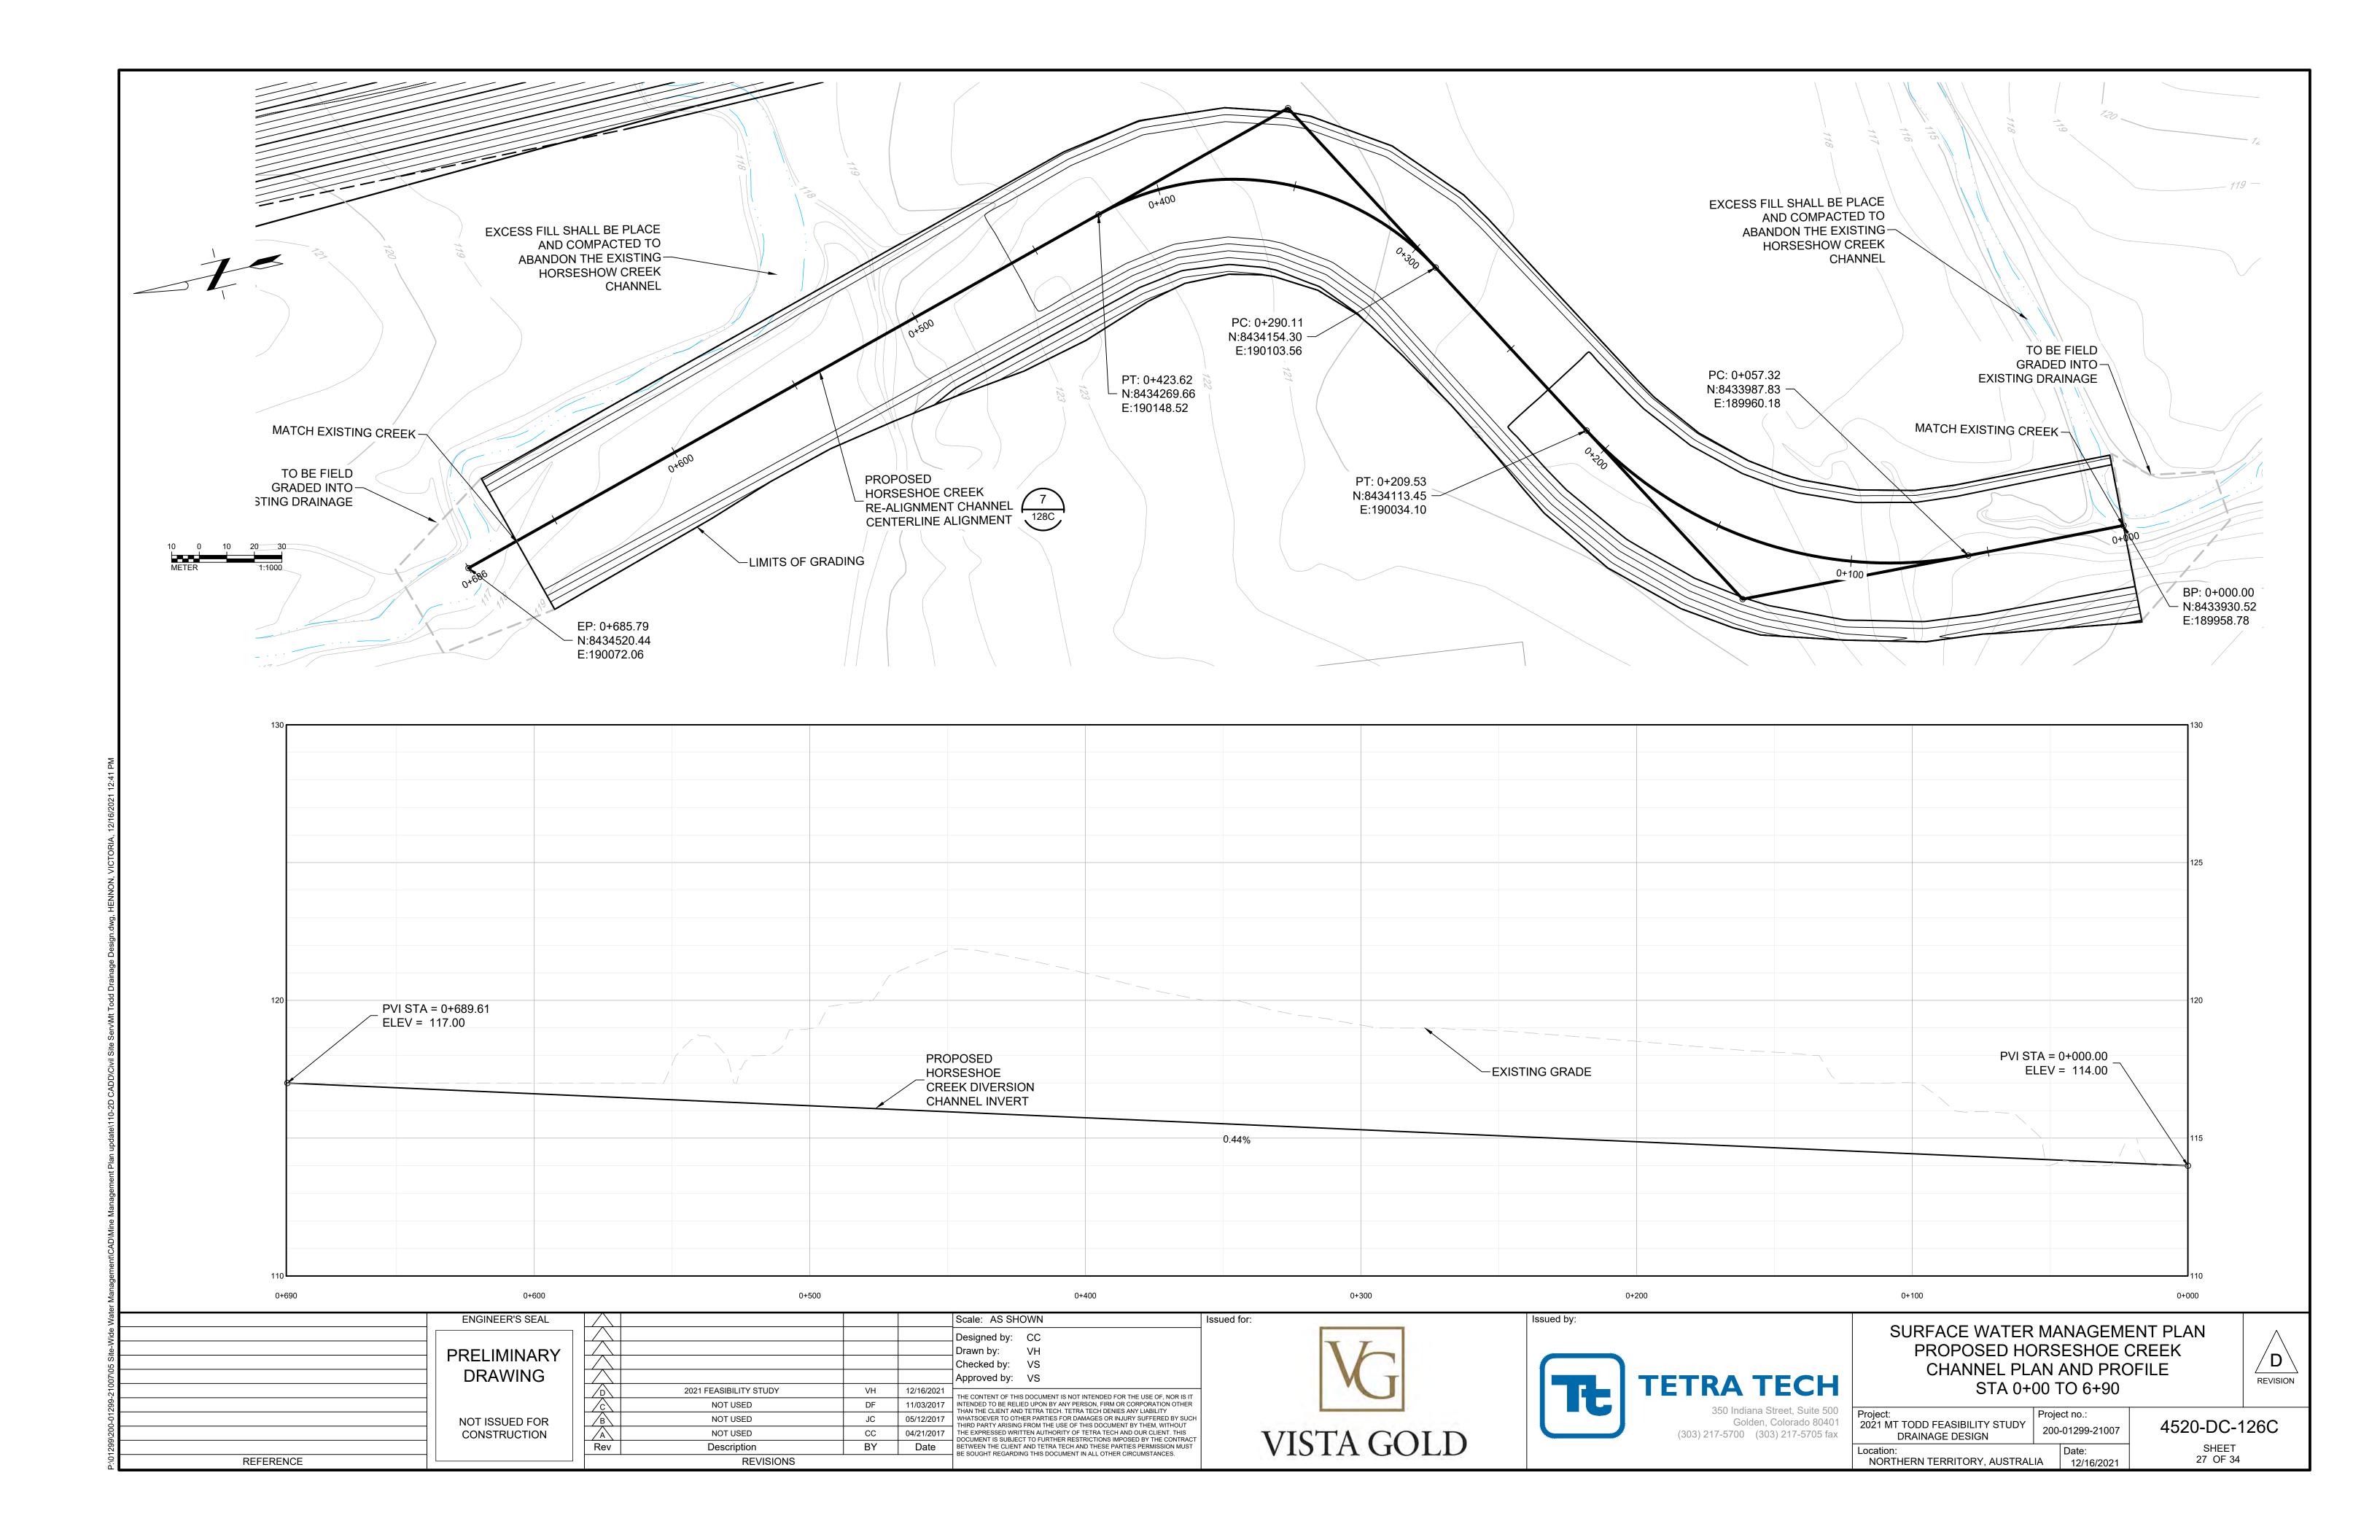


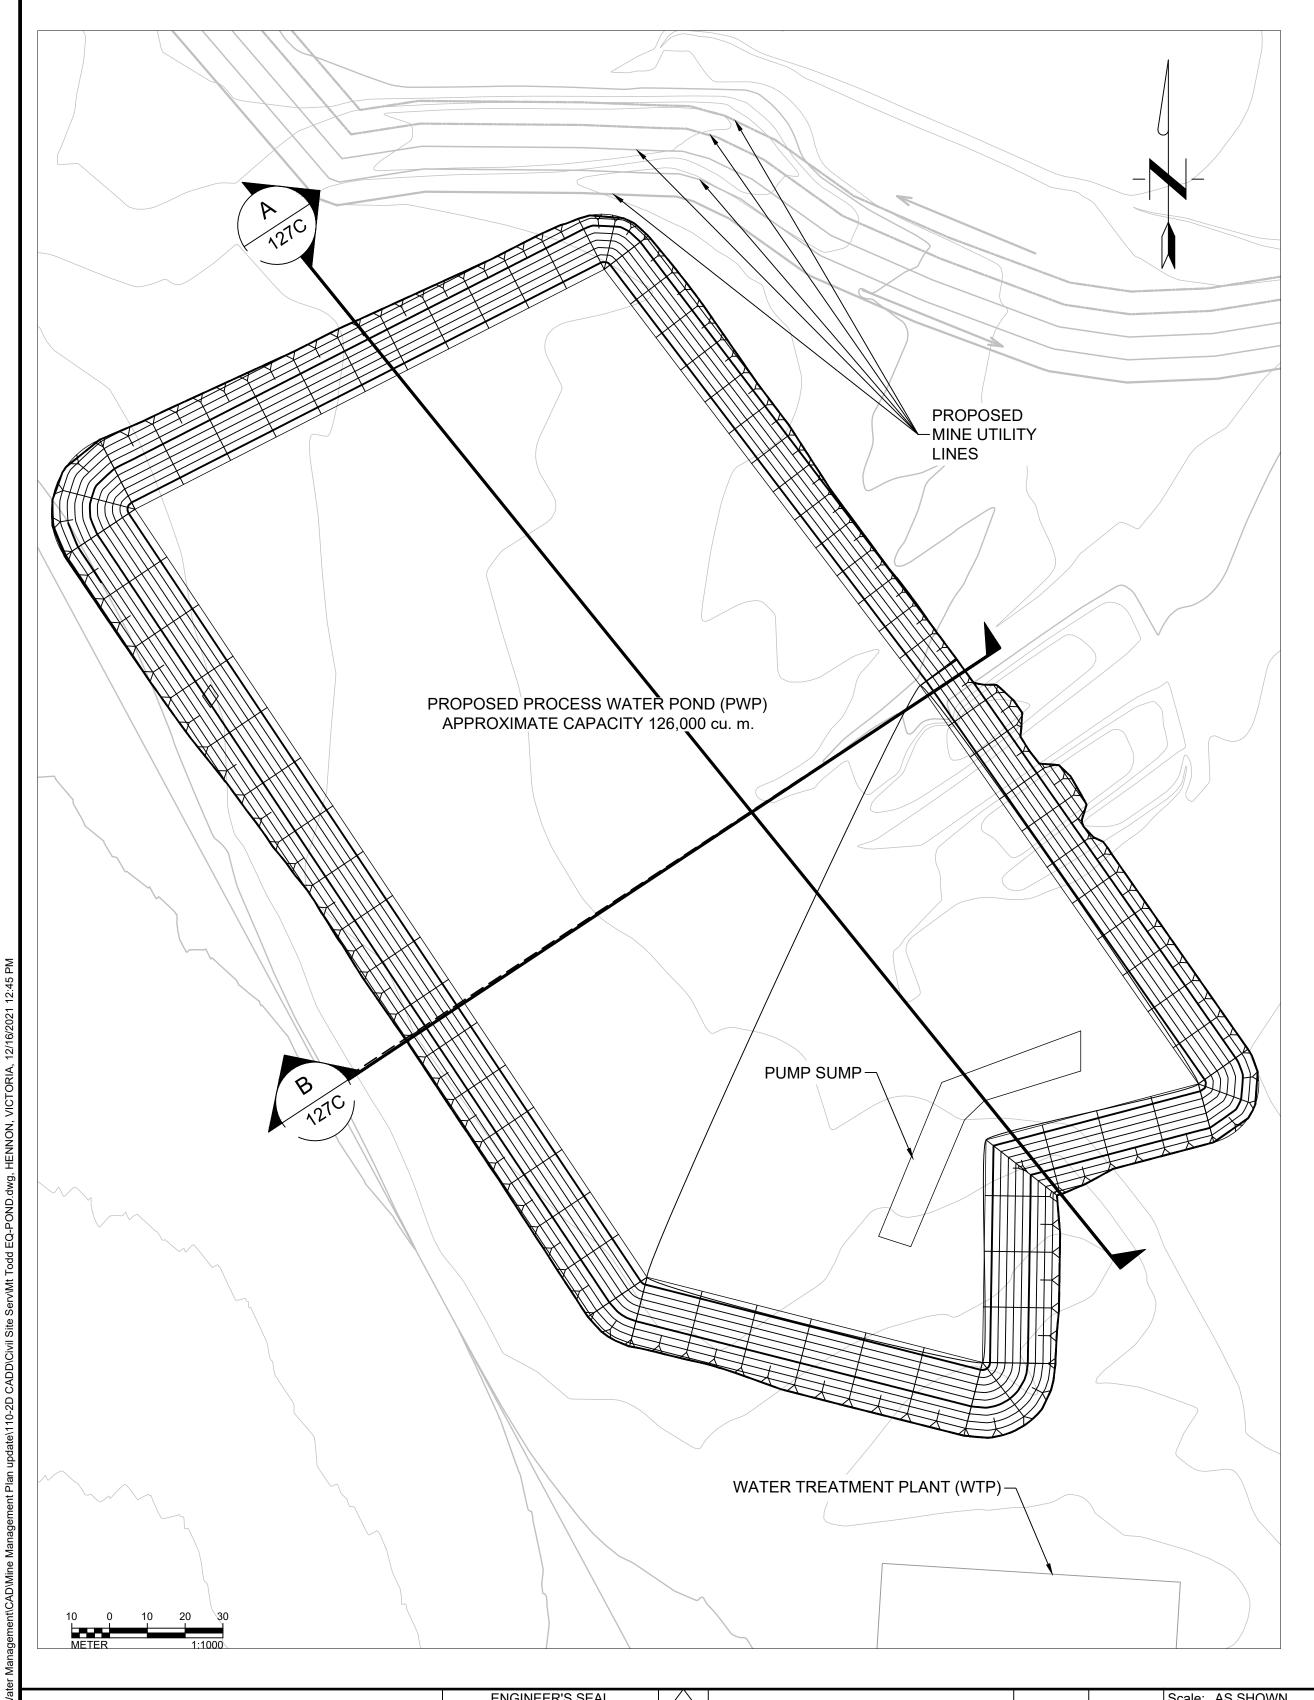

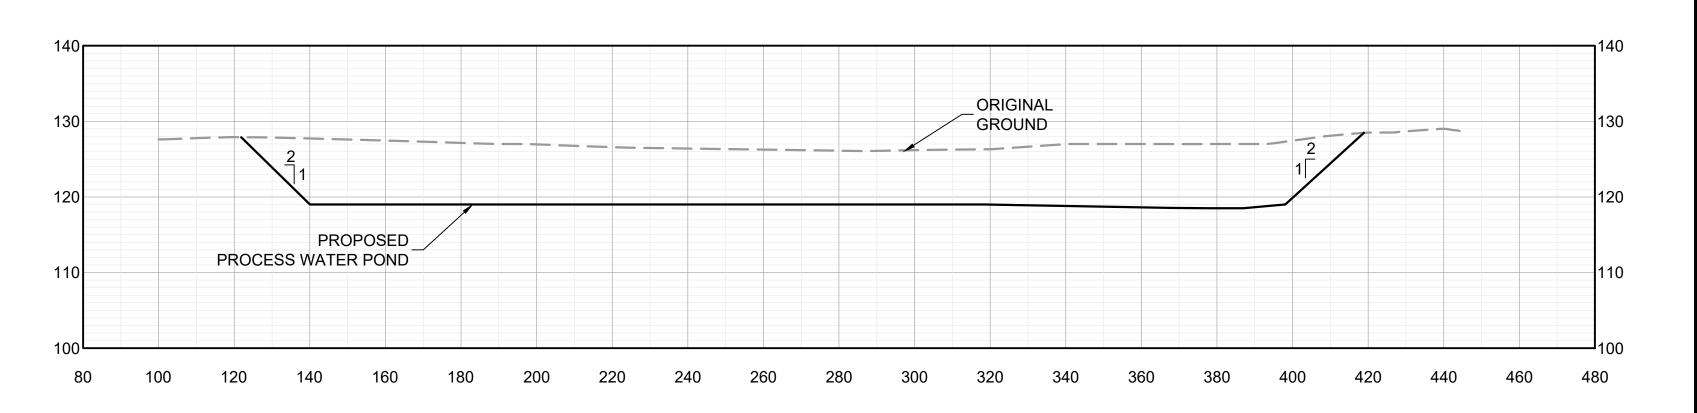



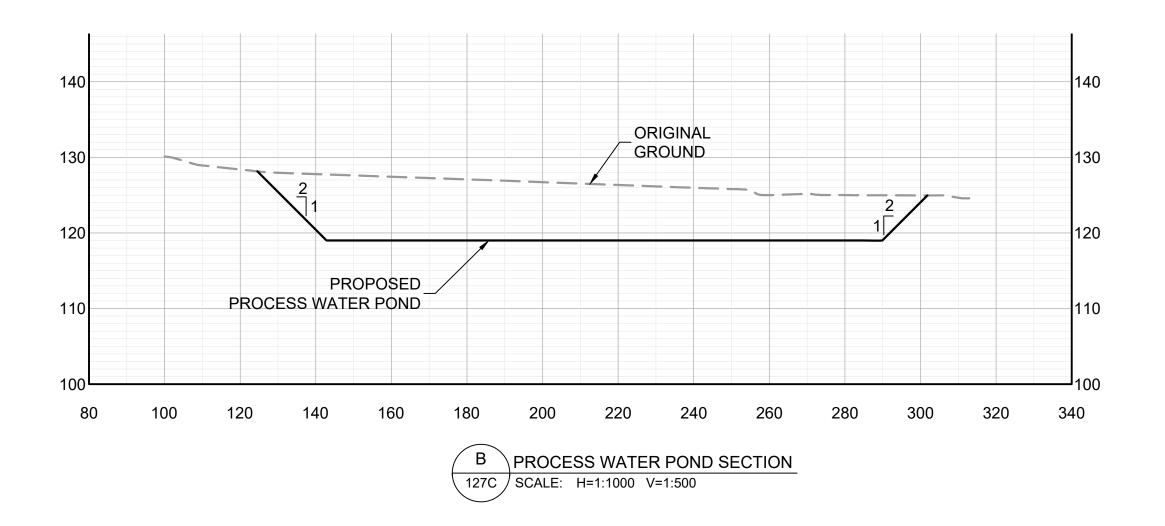

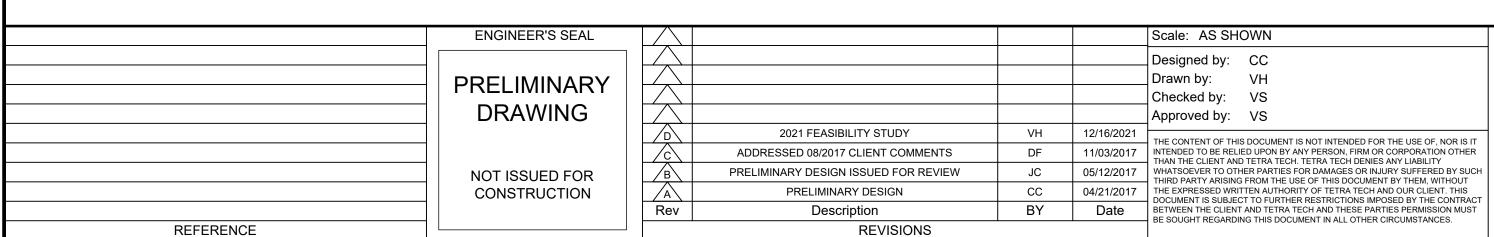







Issued by:


## SURFACE WATER MANAGEMENT PLAN PROPOSED PROCESS WATER POND PLAN AND PROFILE


D


Project: 2021 MT TODD FEASIBILITY STUDY DRAINAGE DESIGN		ect no.:	4520-DC-127C	
		-01299-21007		
Location: NORTHERN TERRITORY, AUSTRALIA		Date: 12/16/2021	SHEET 28 OF 34	

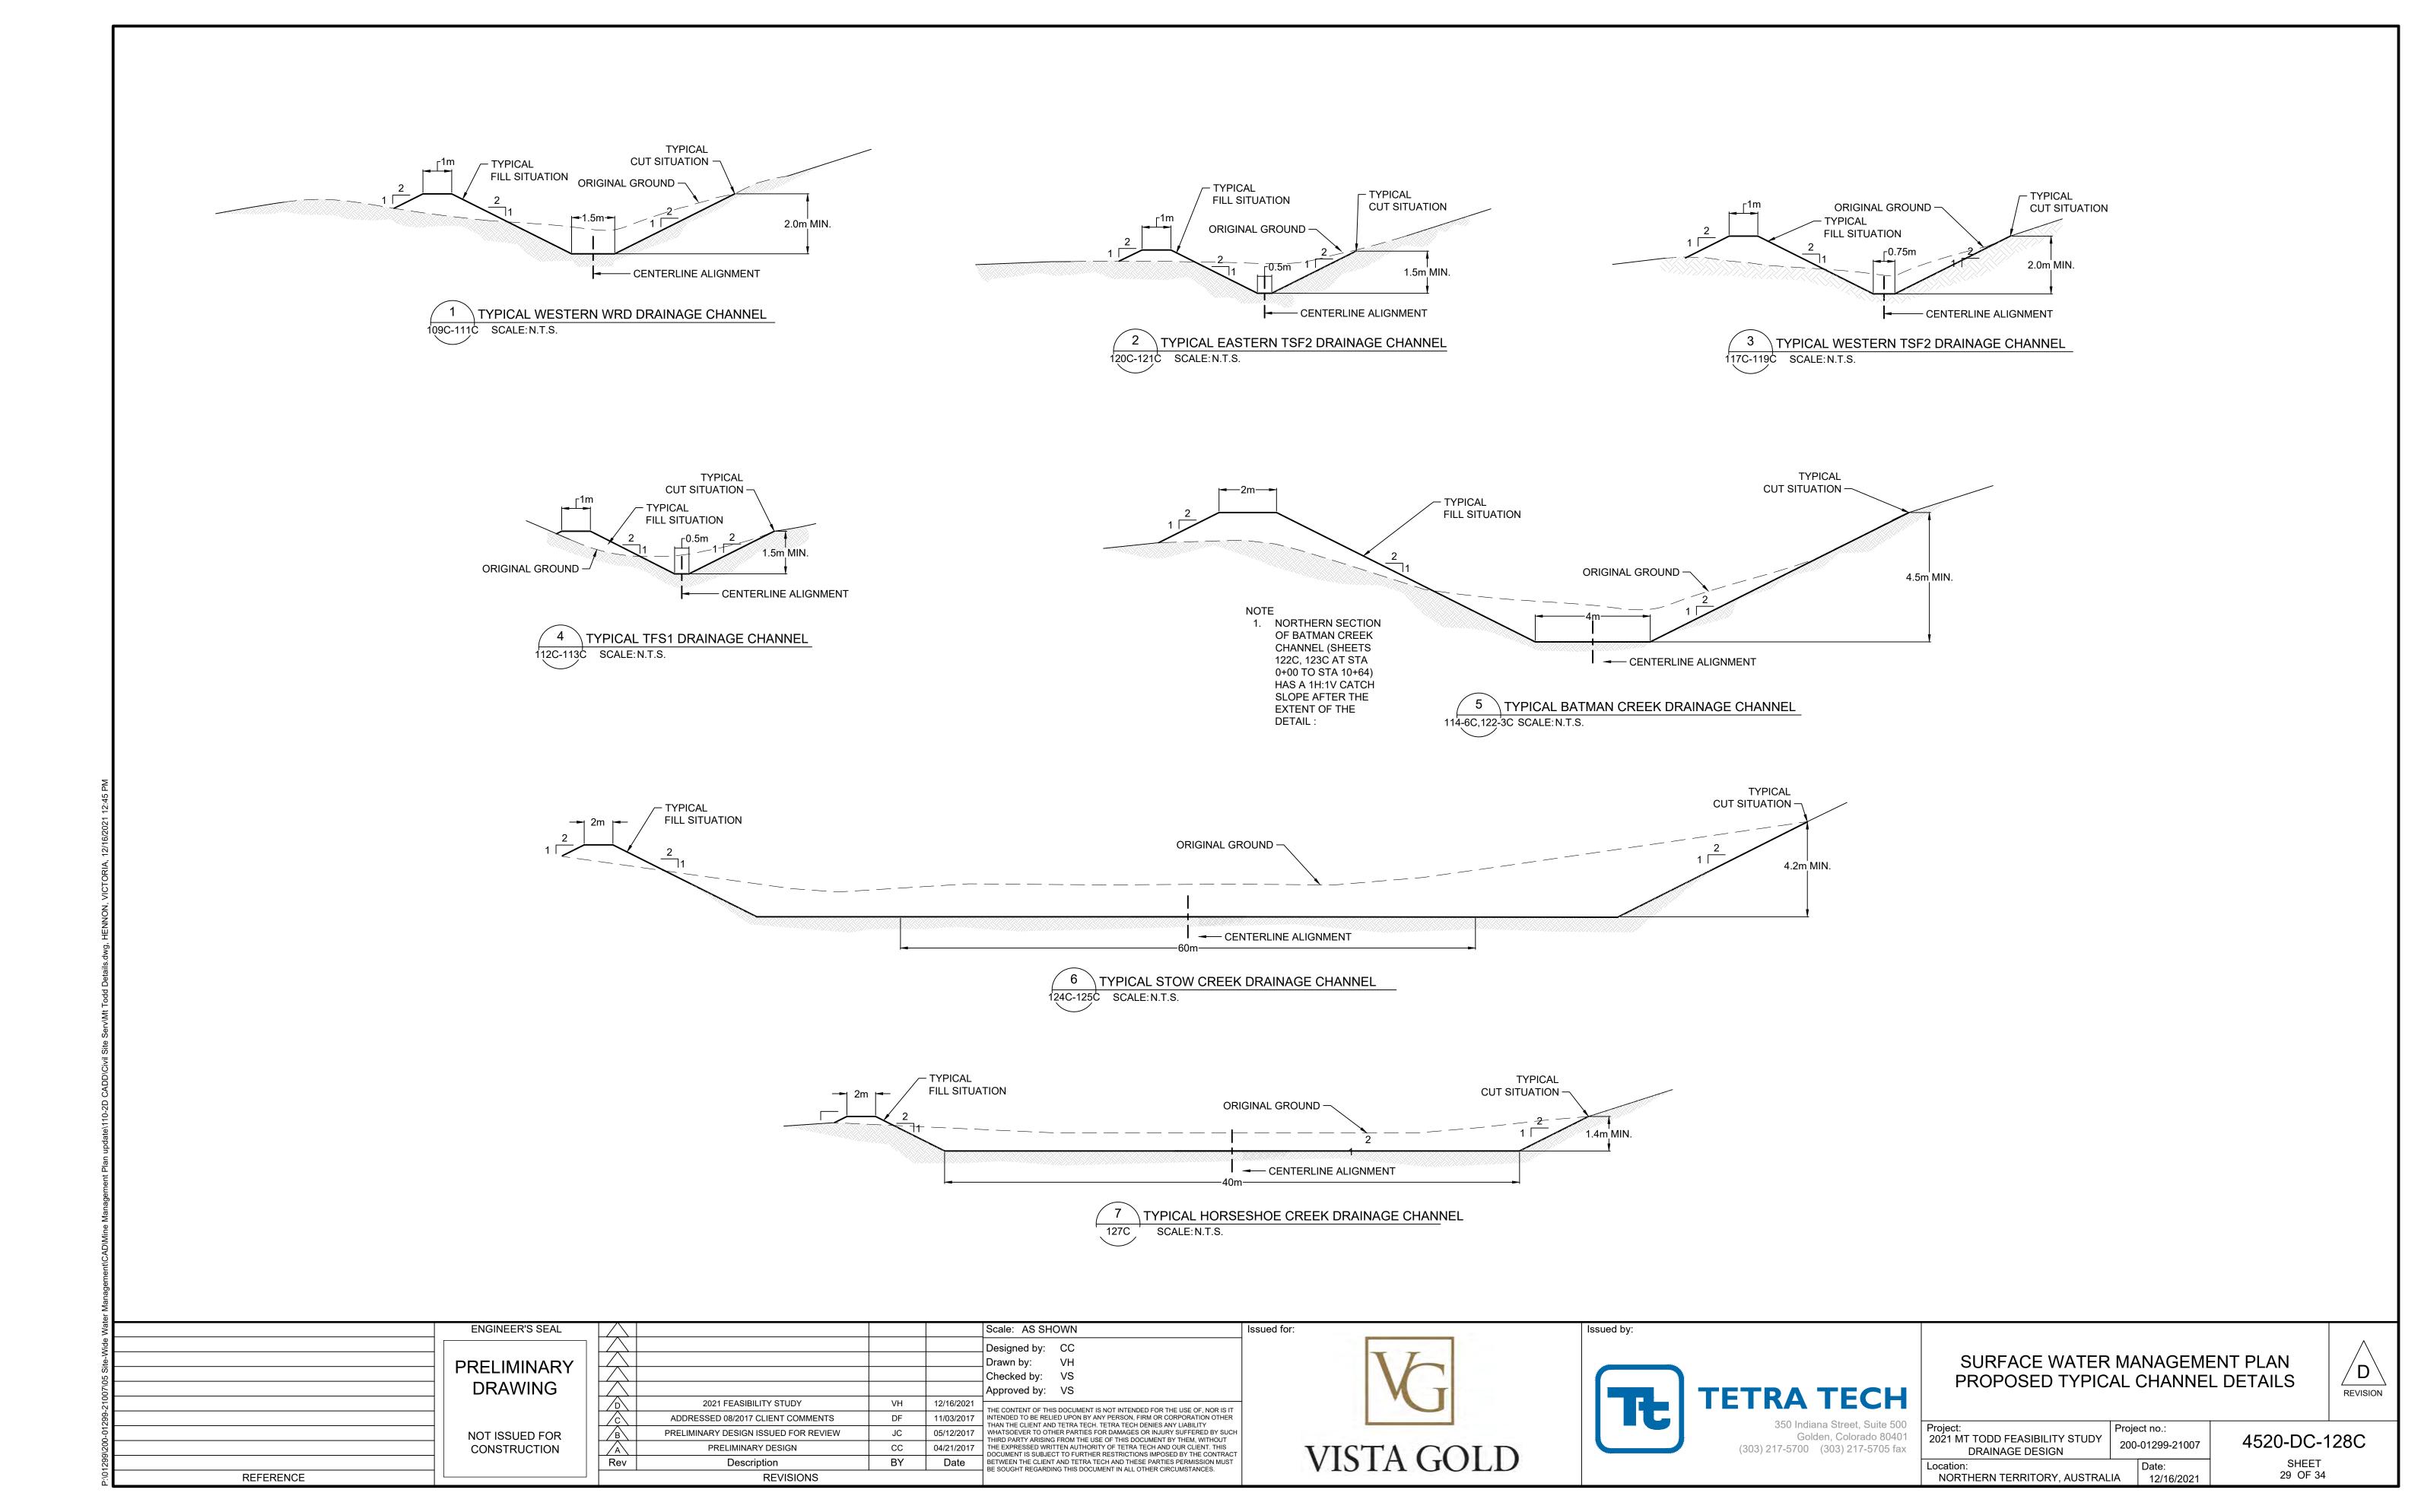


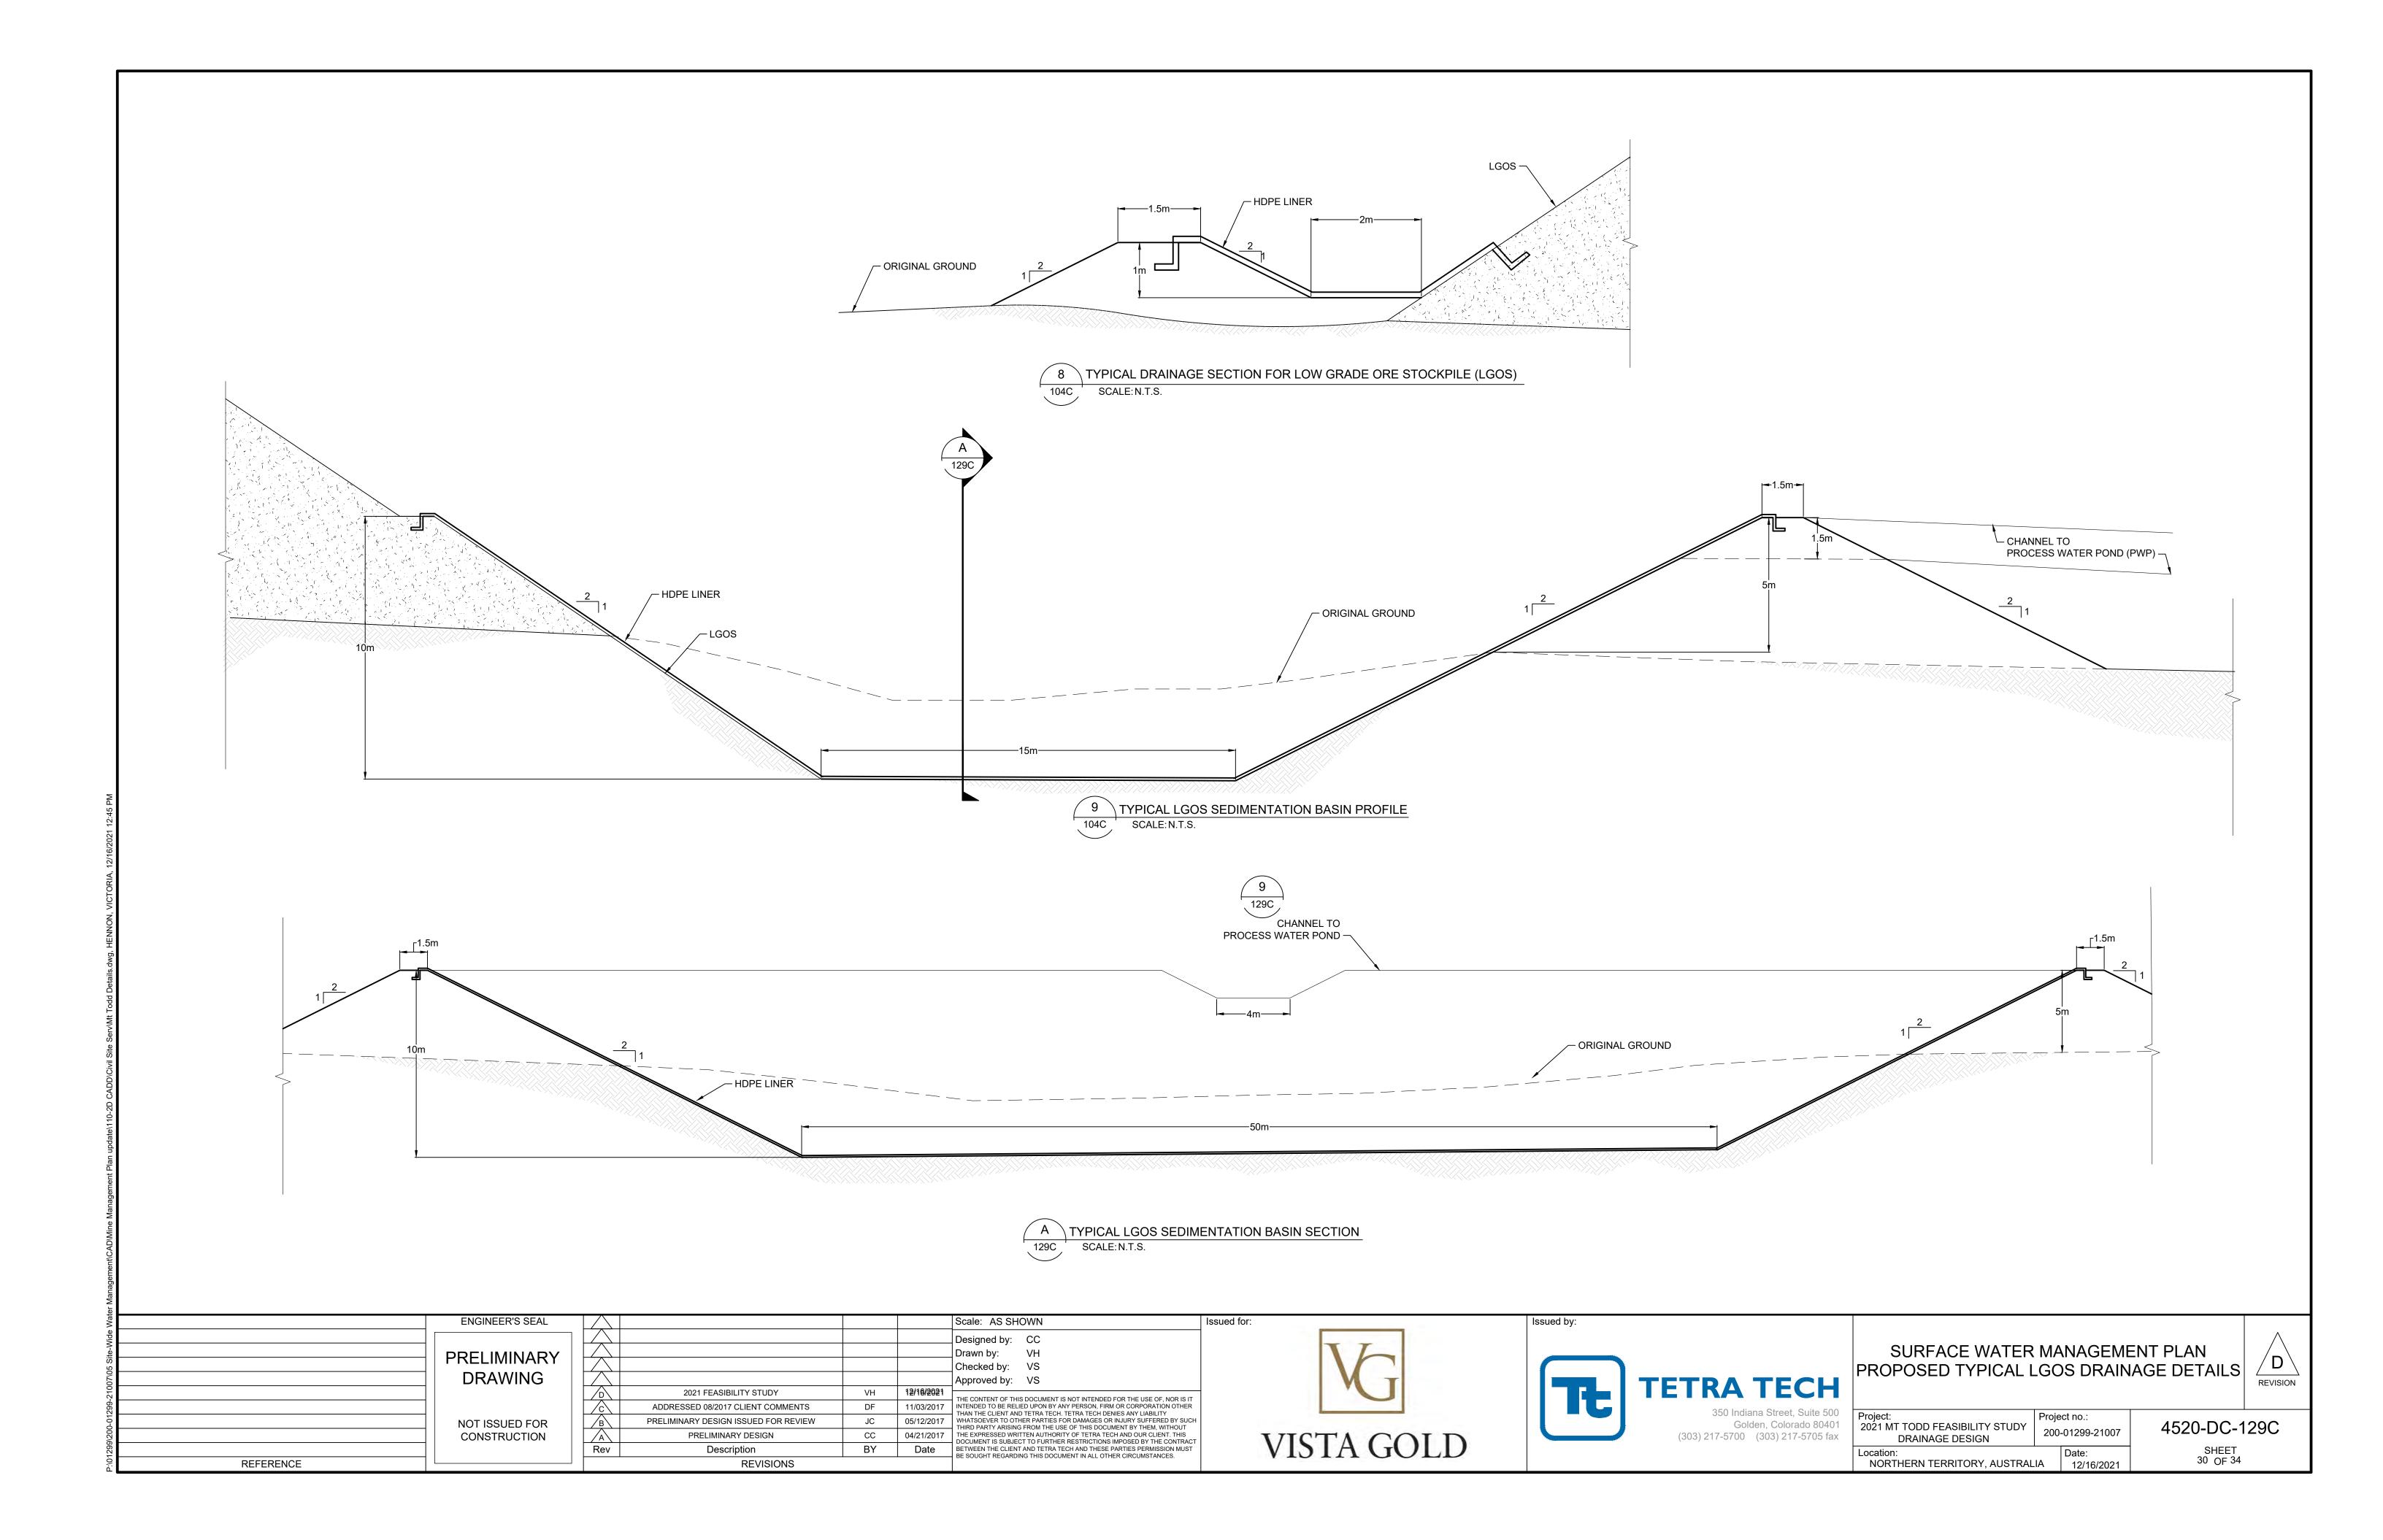


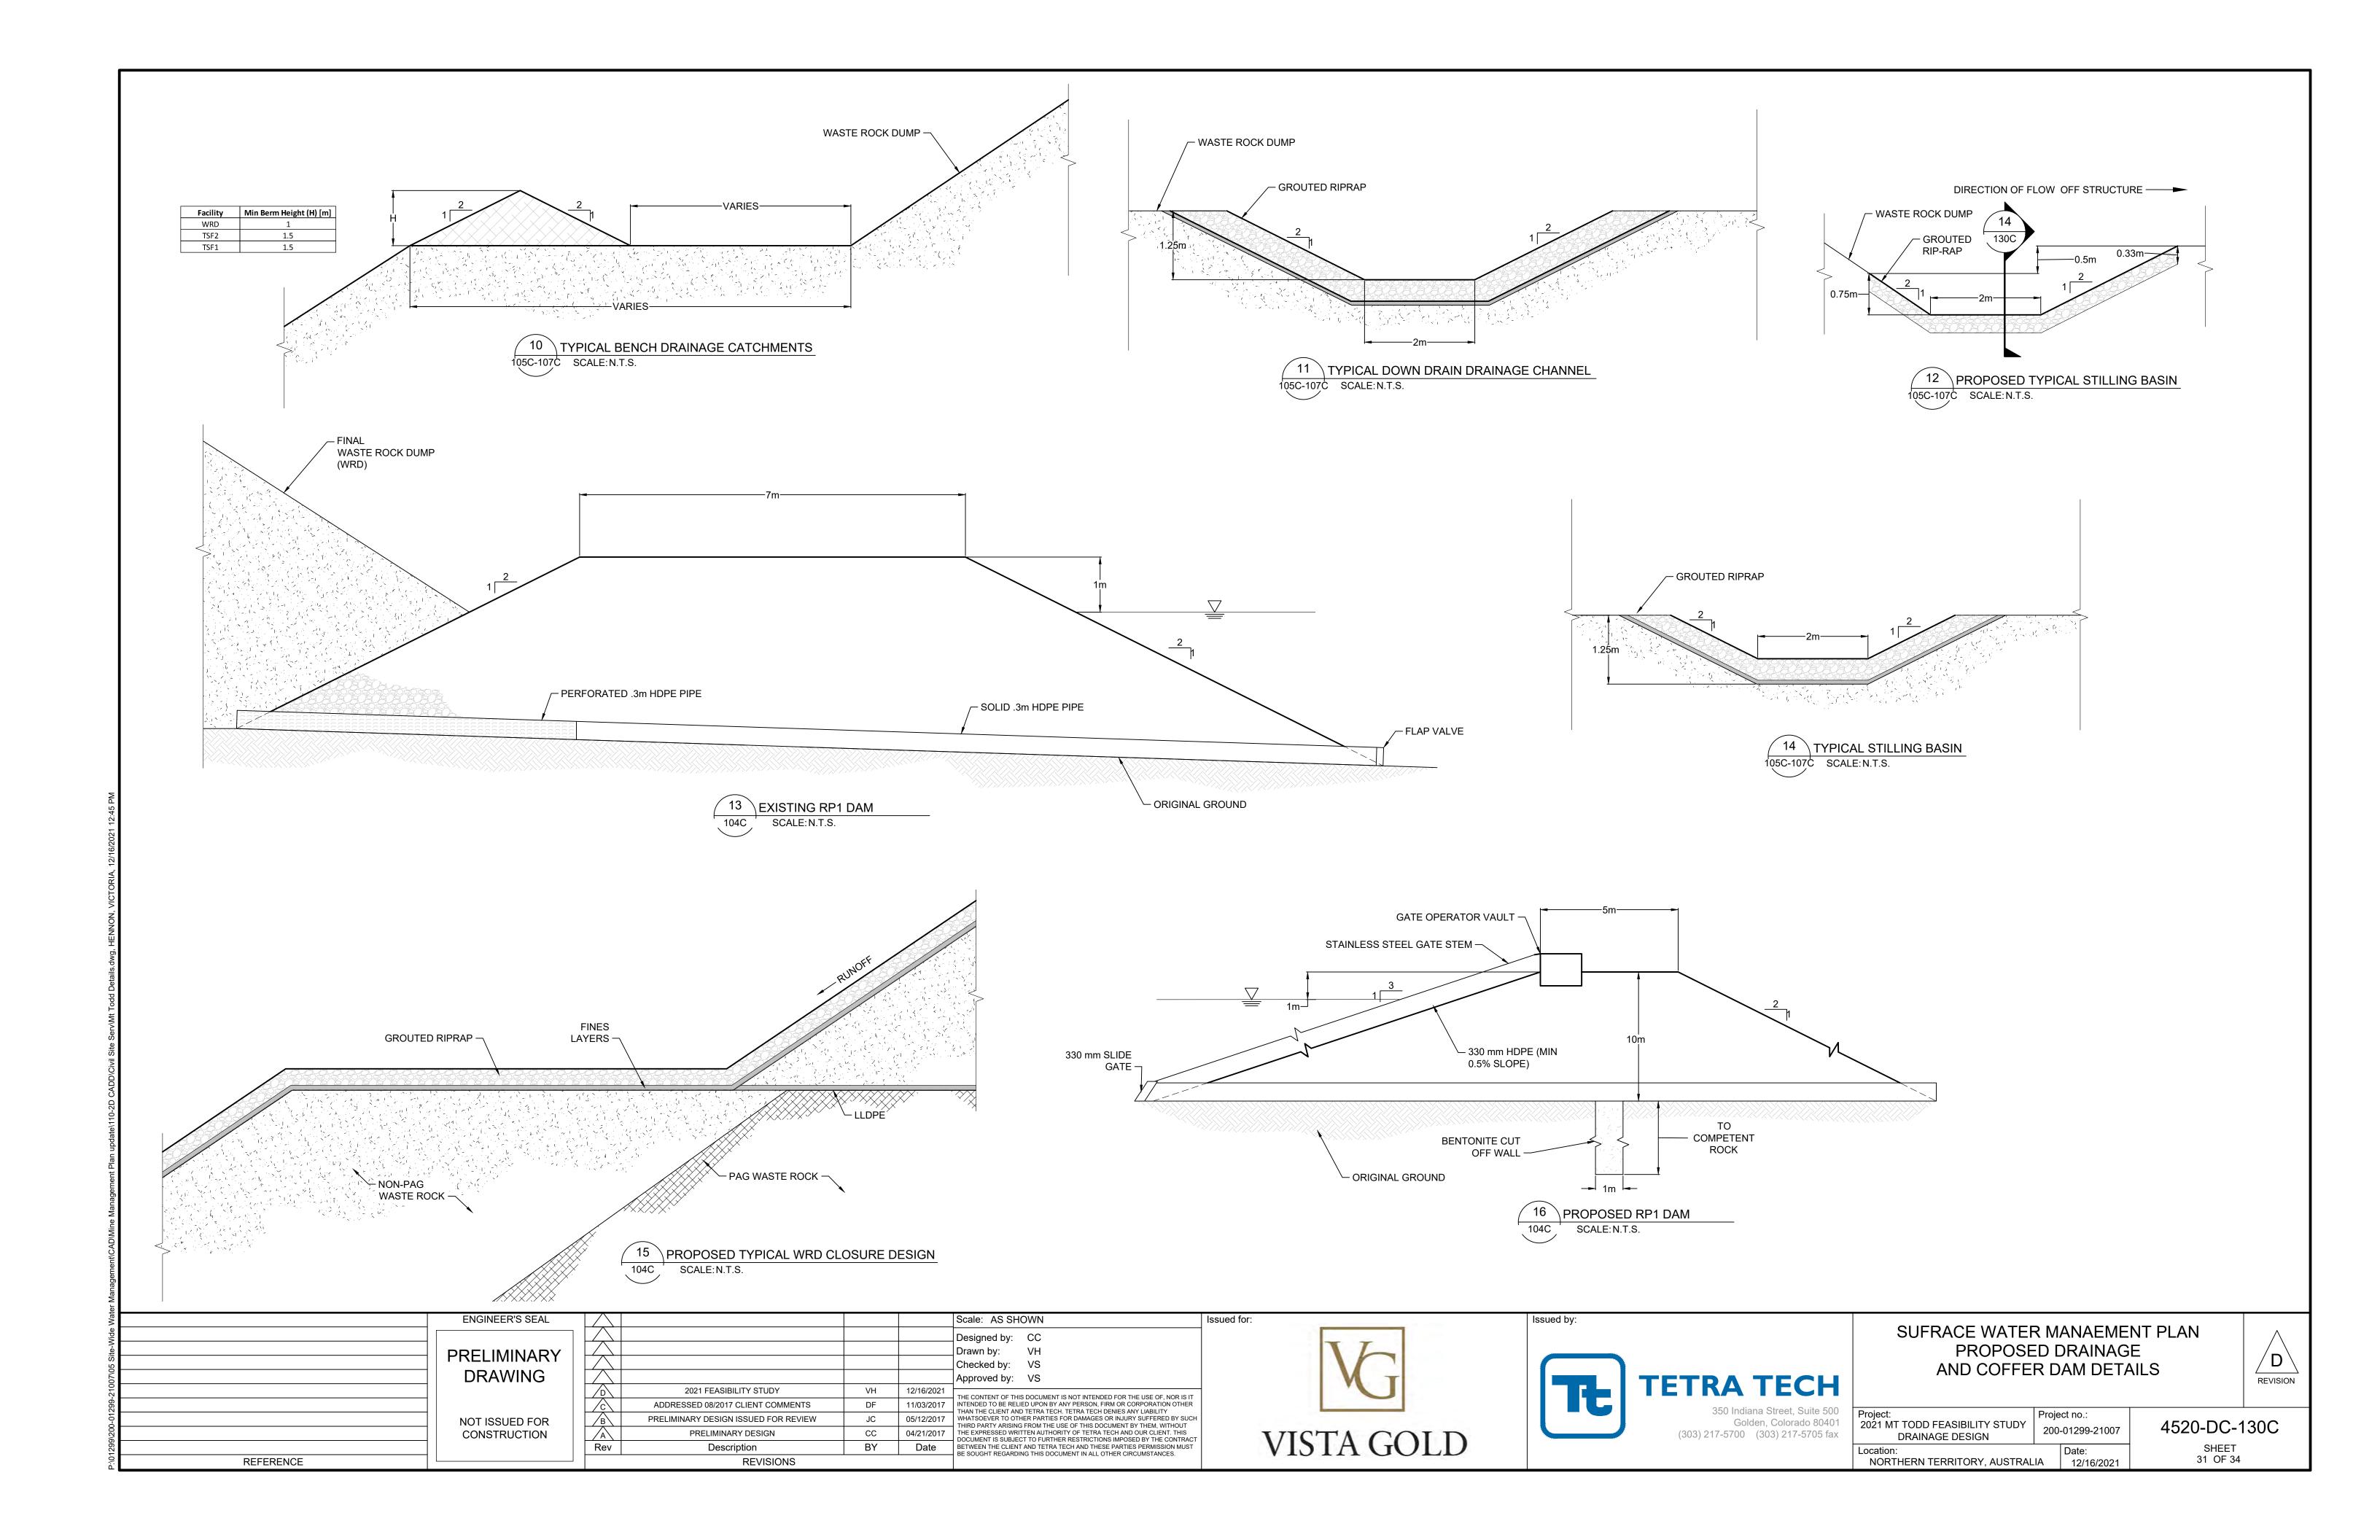

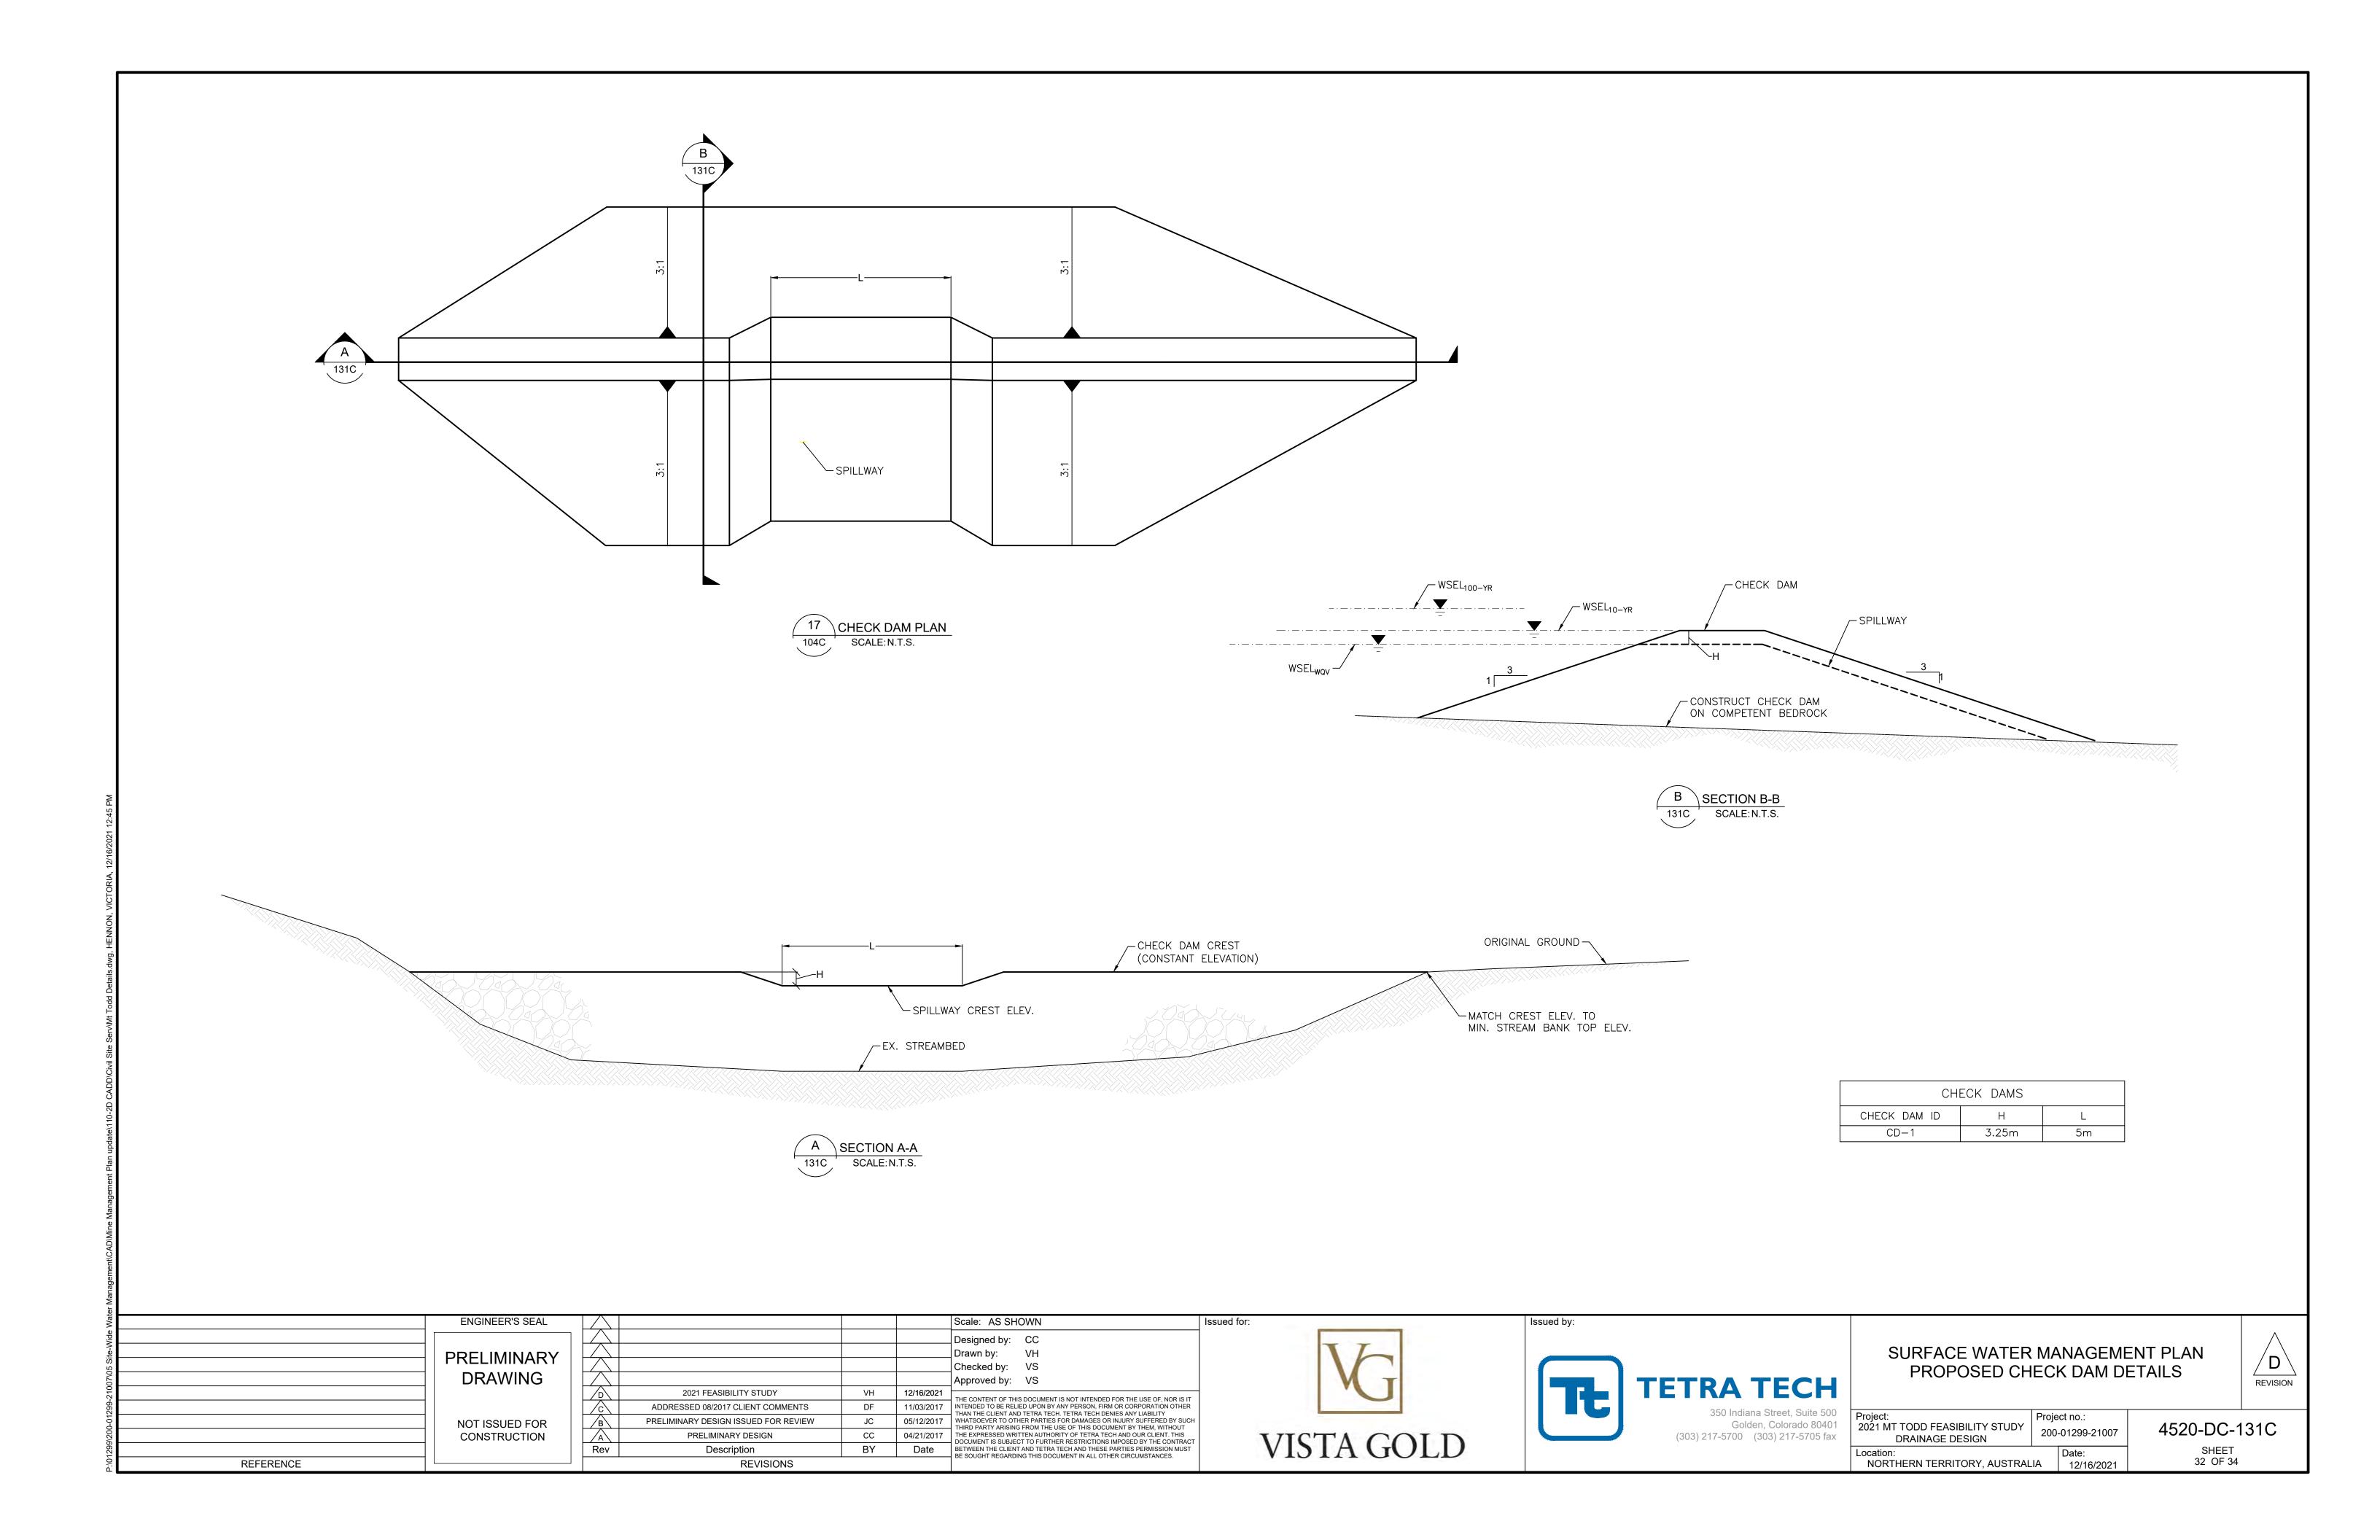

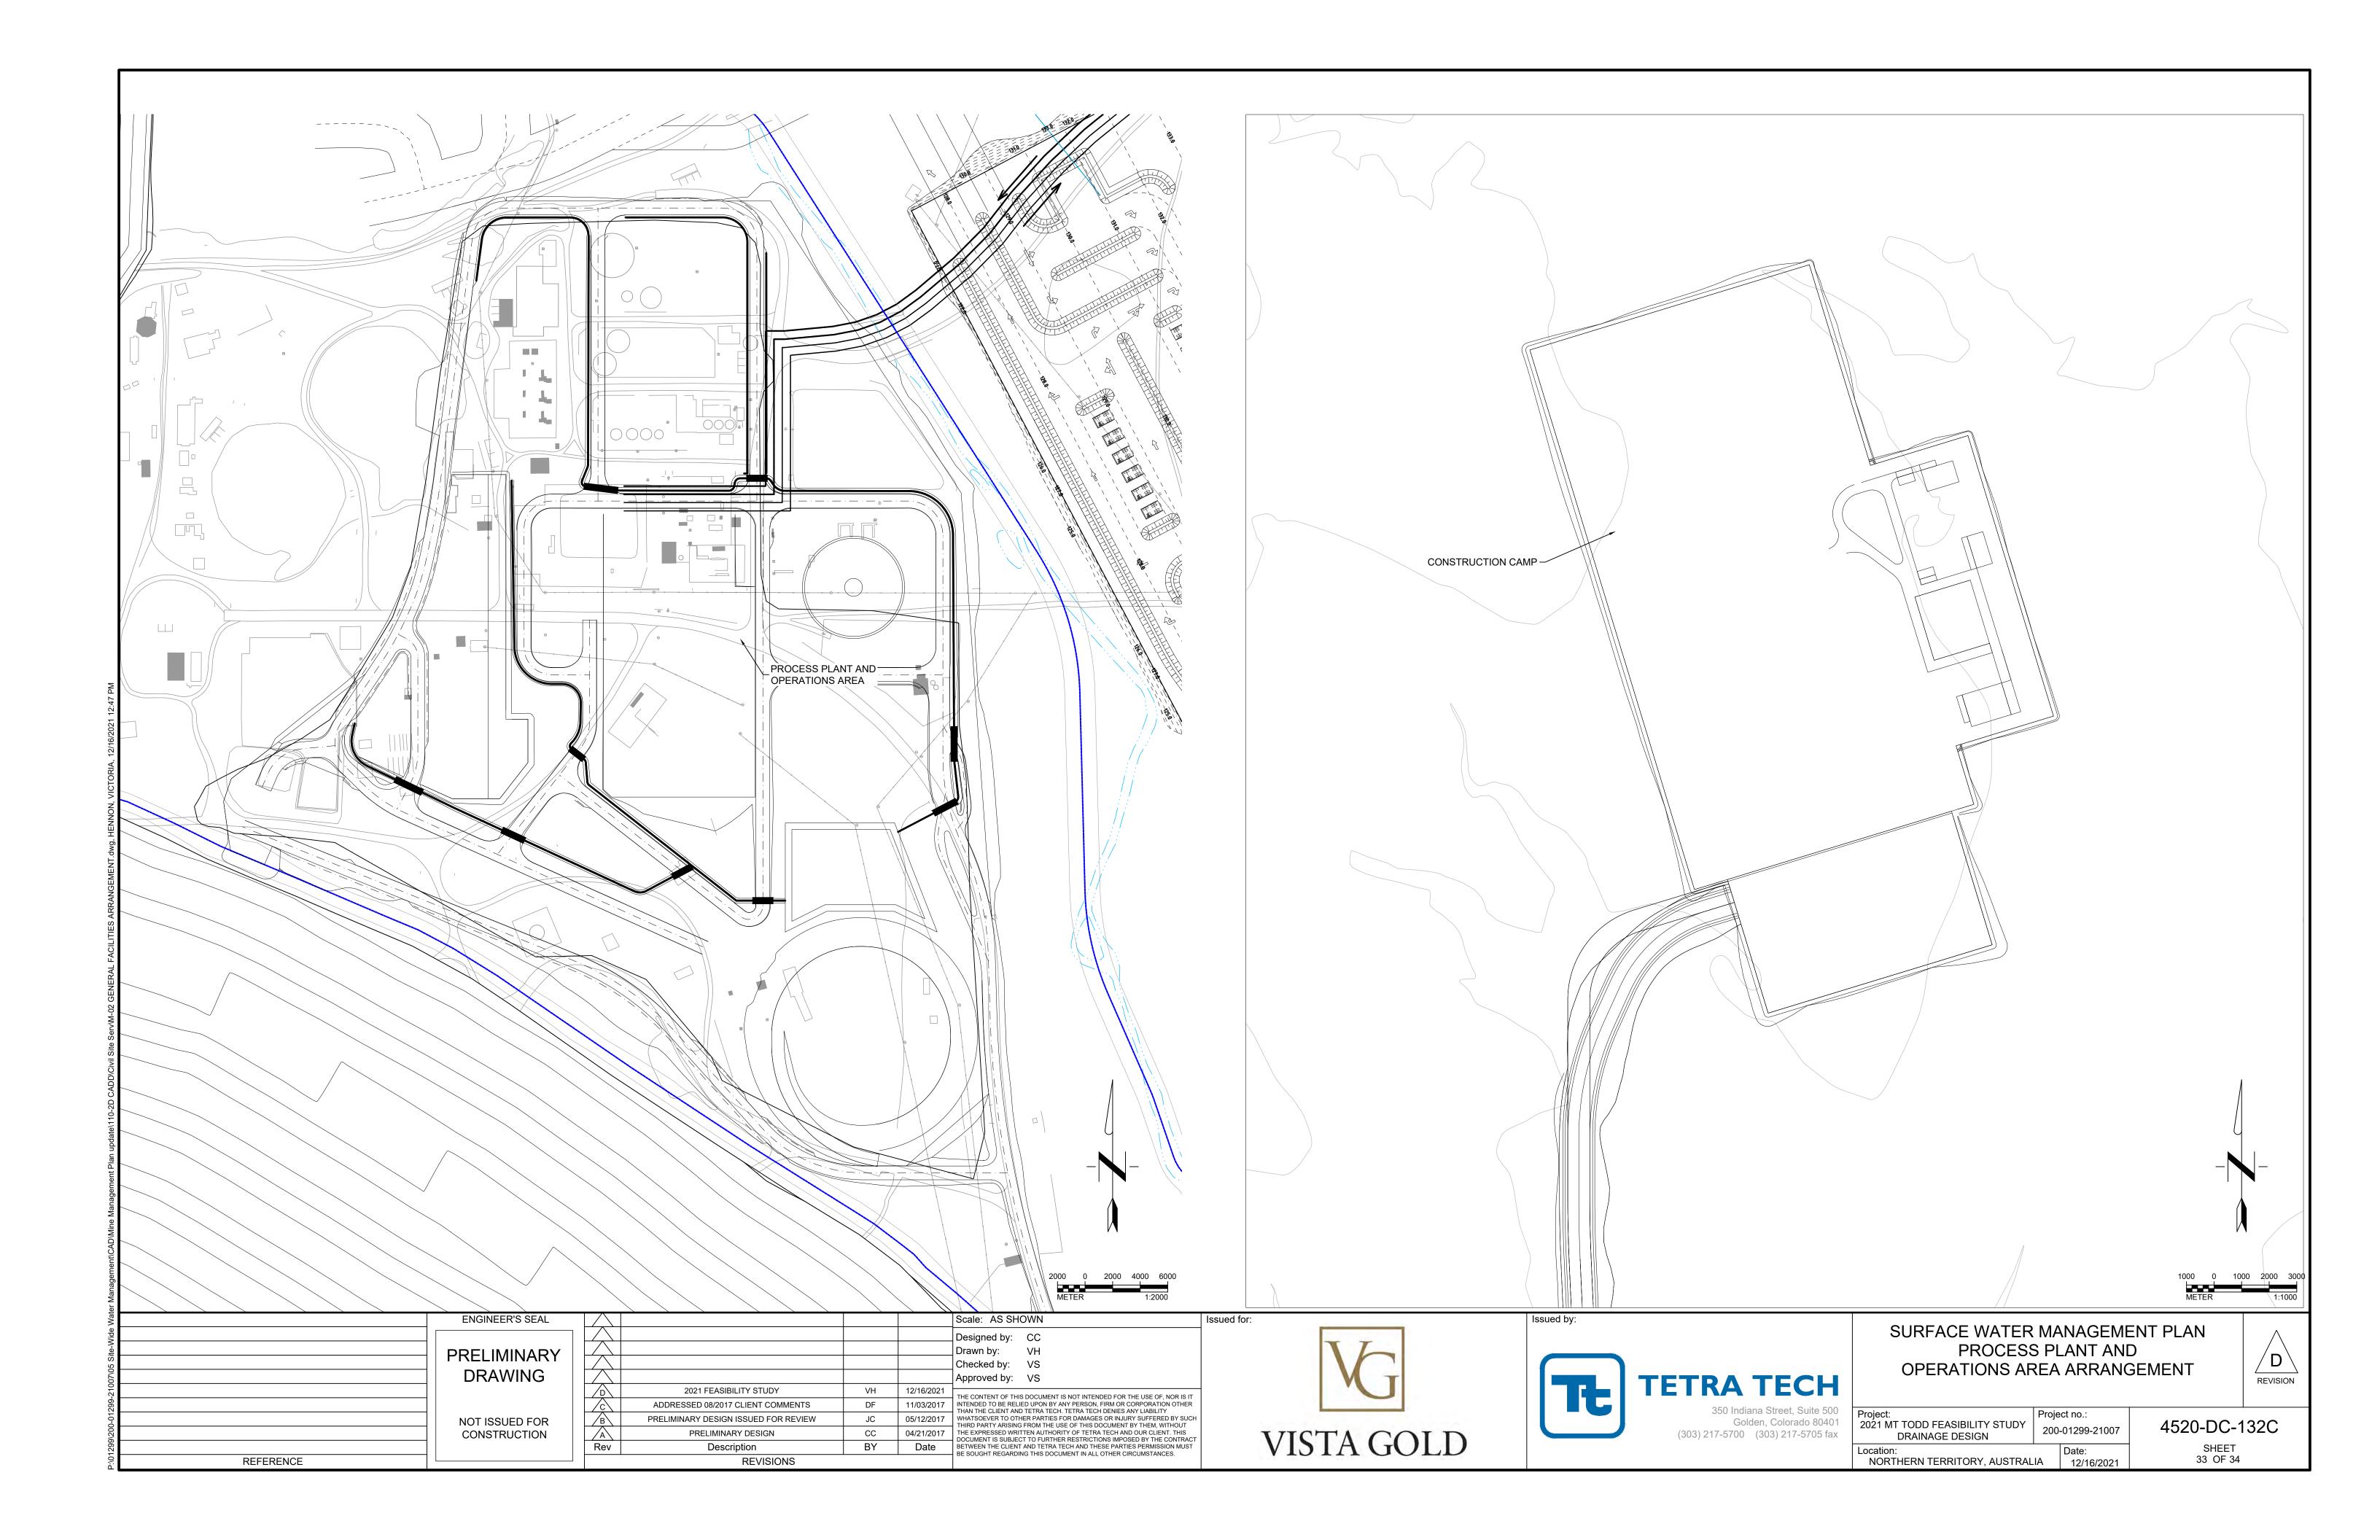

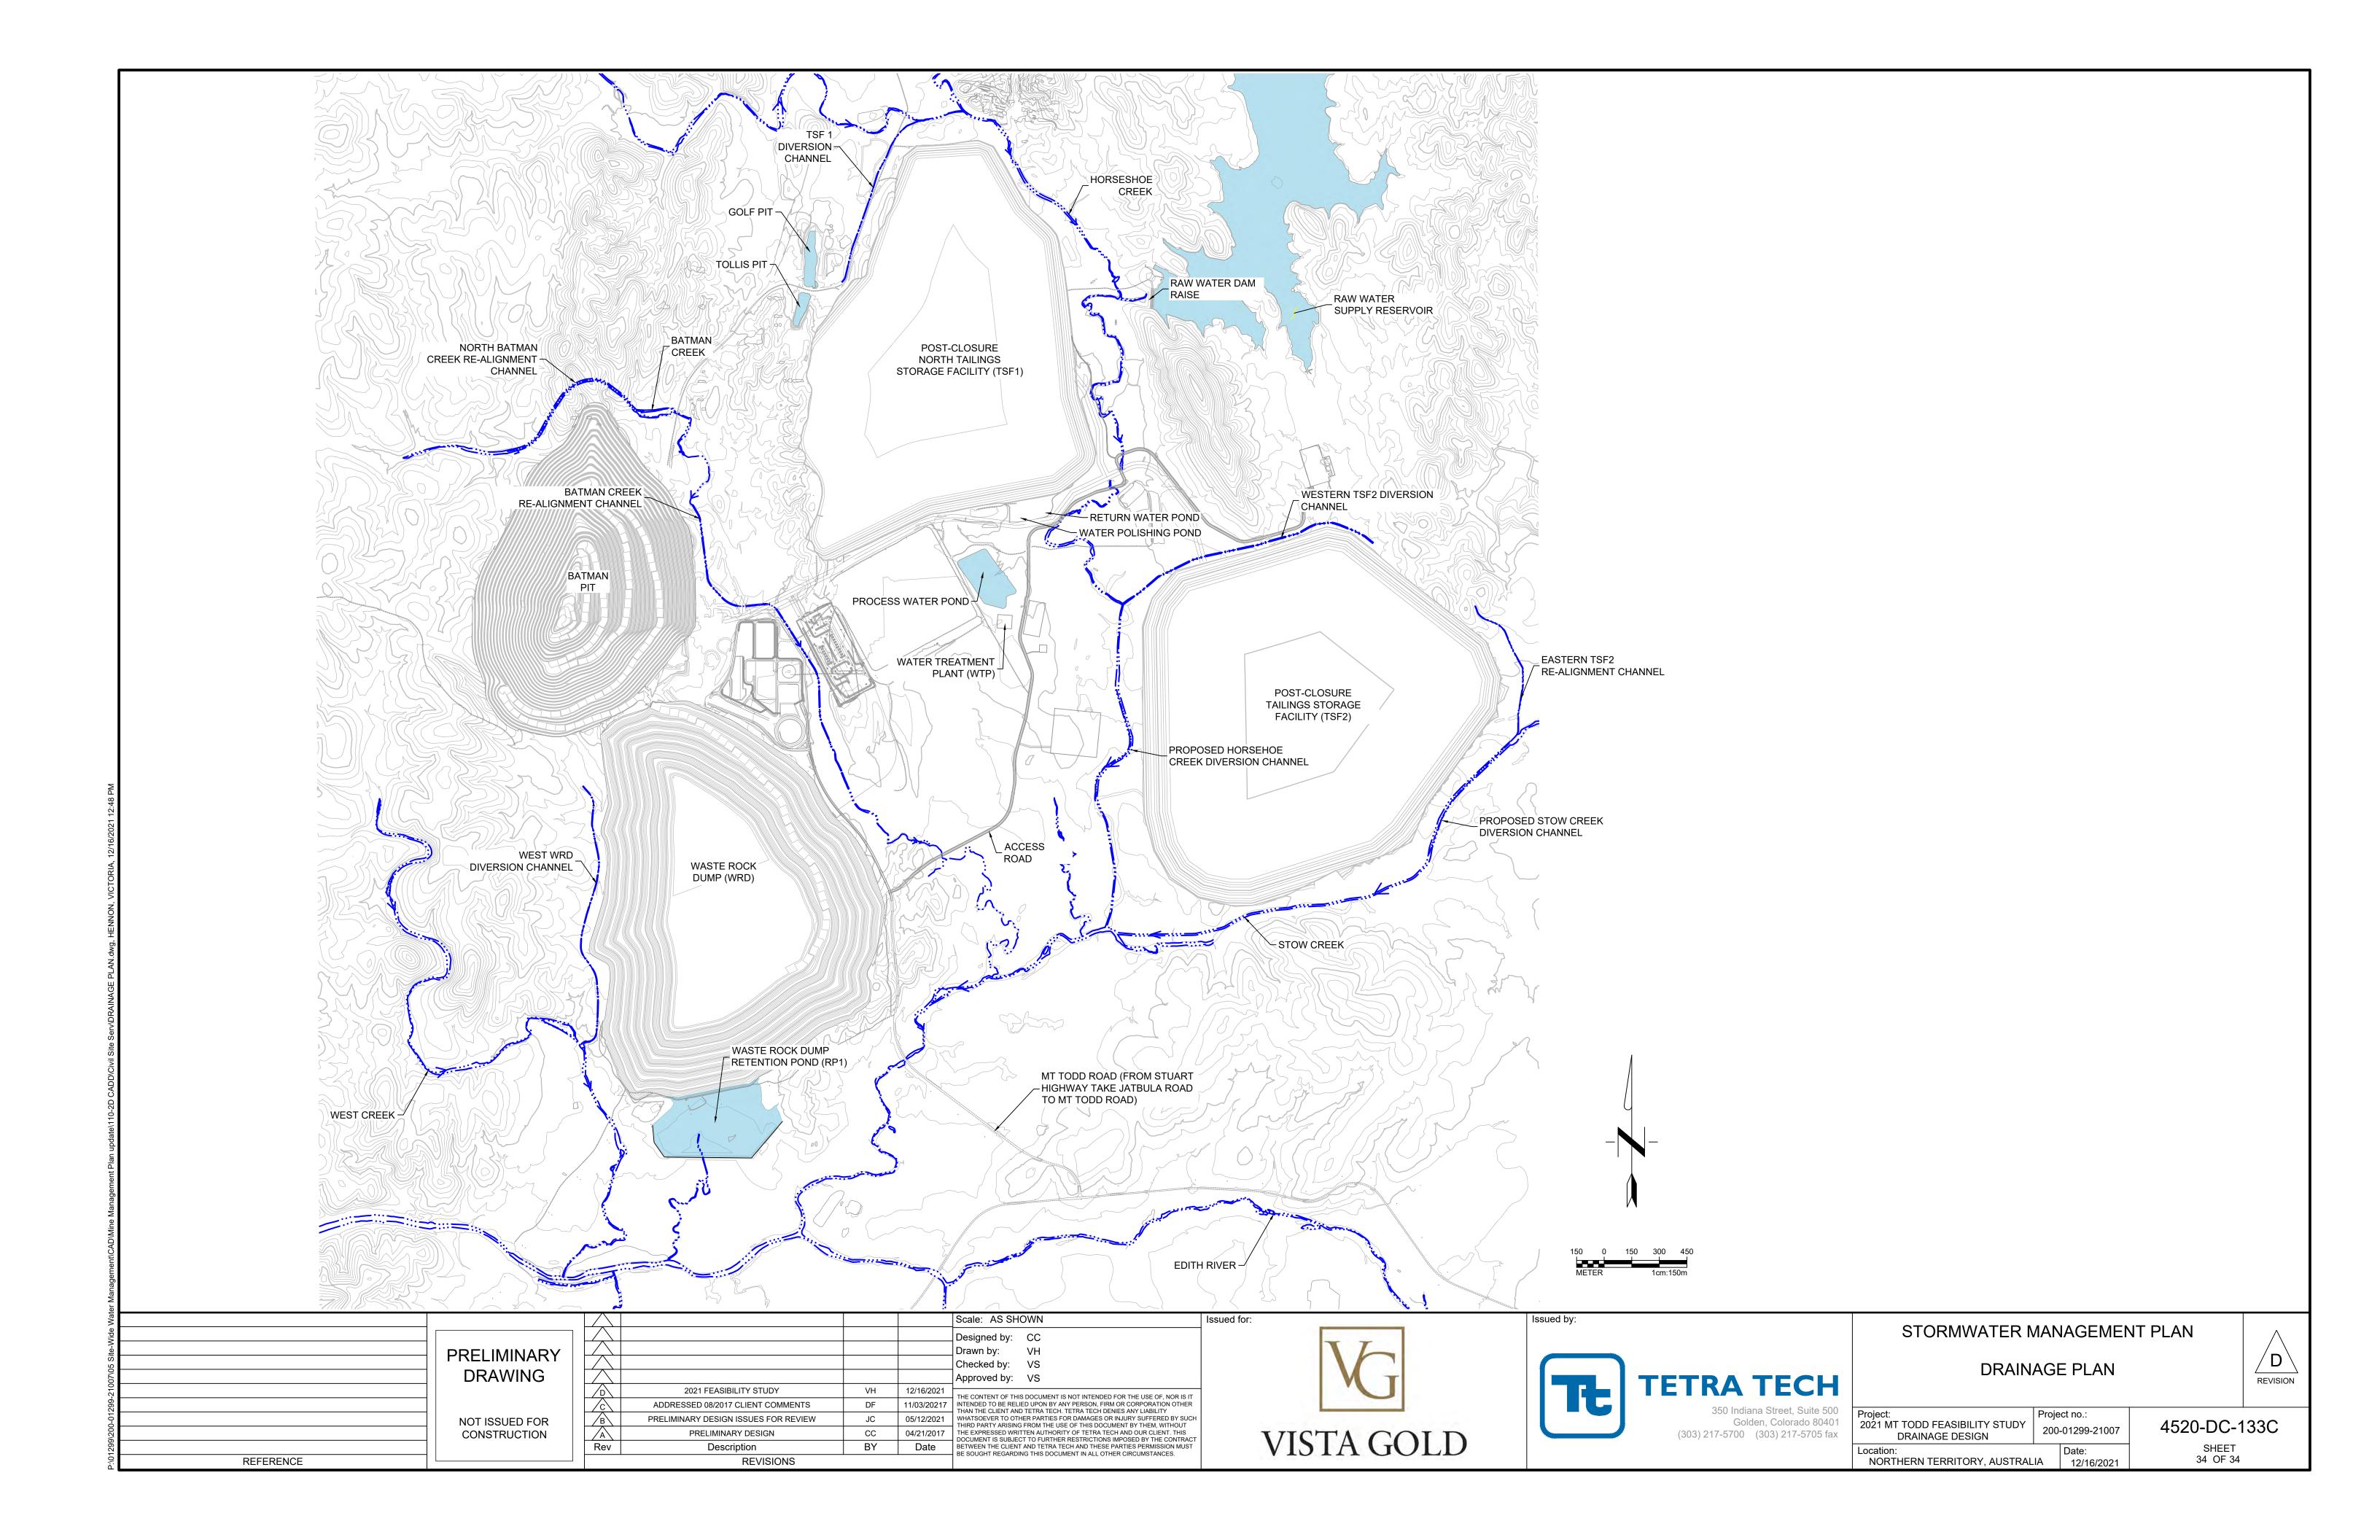

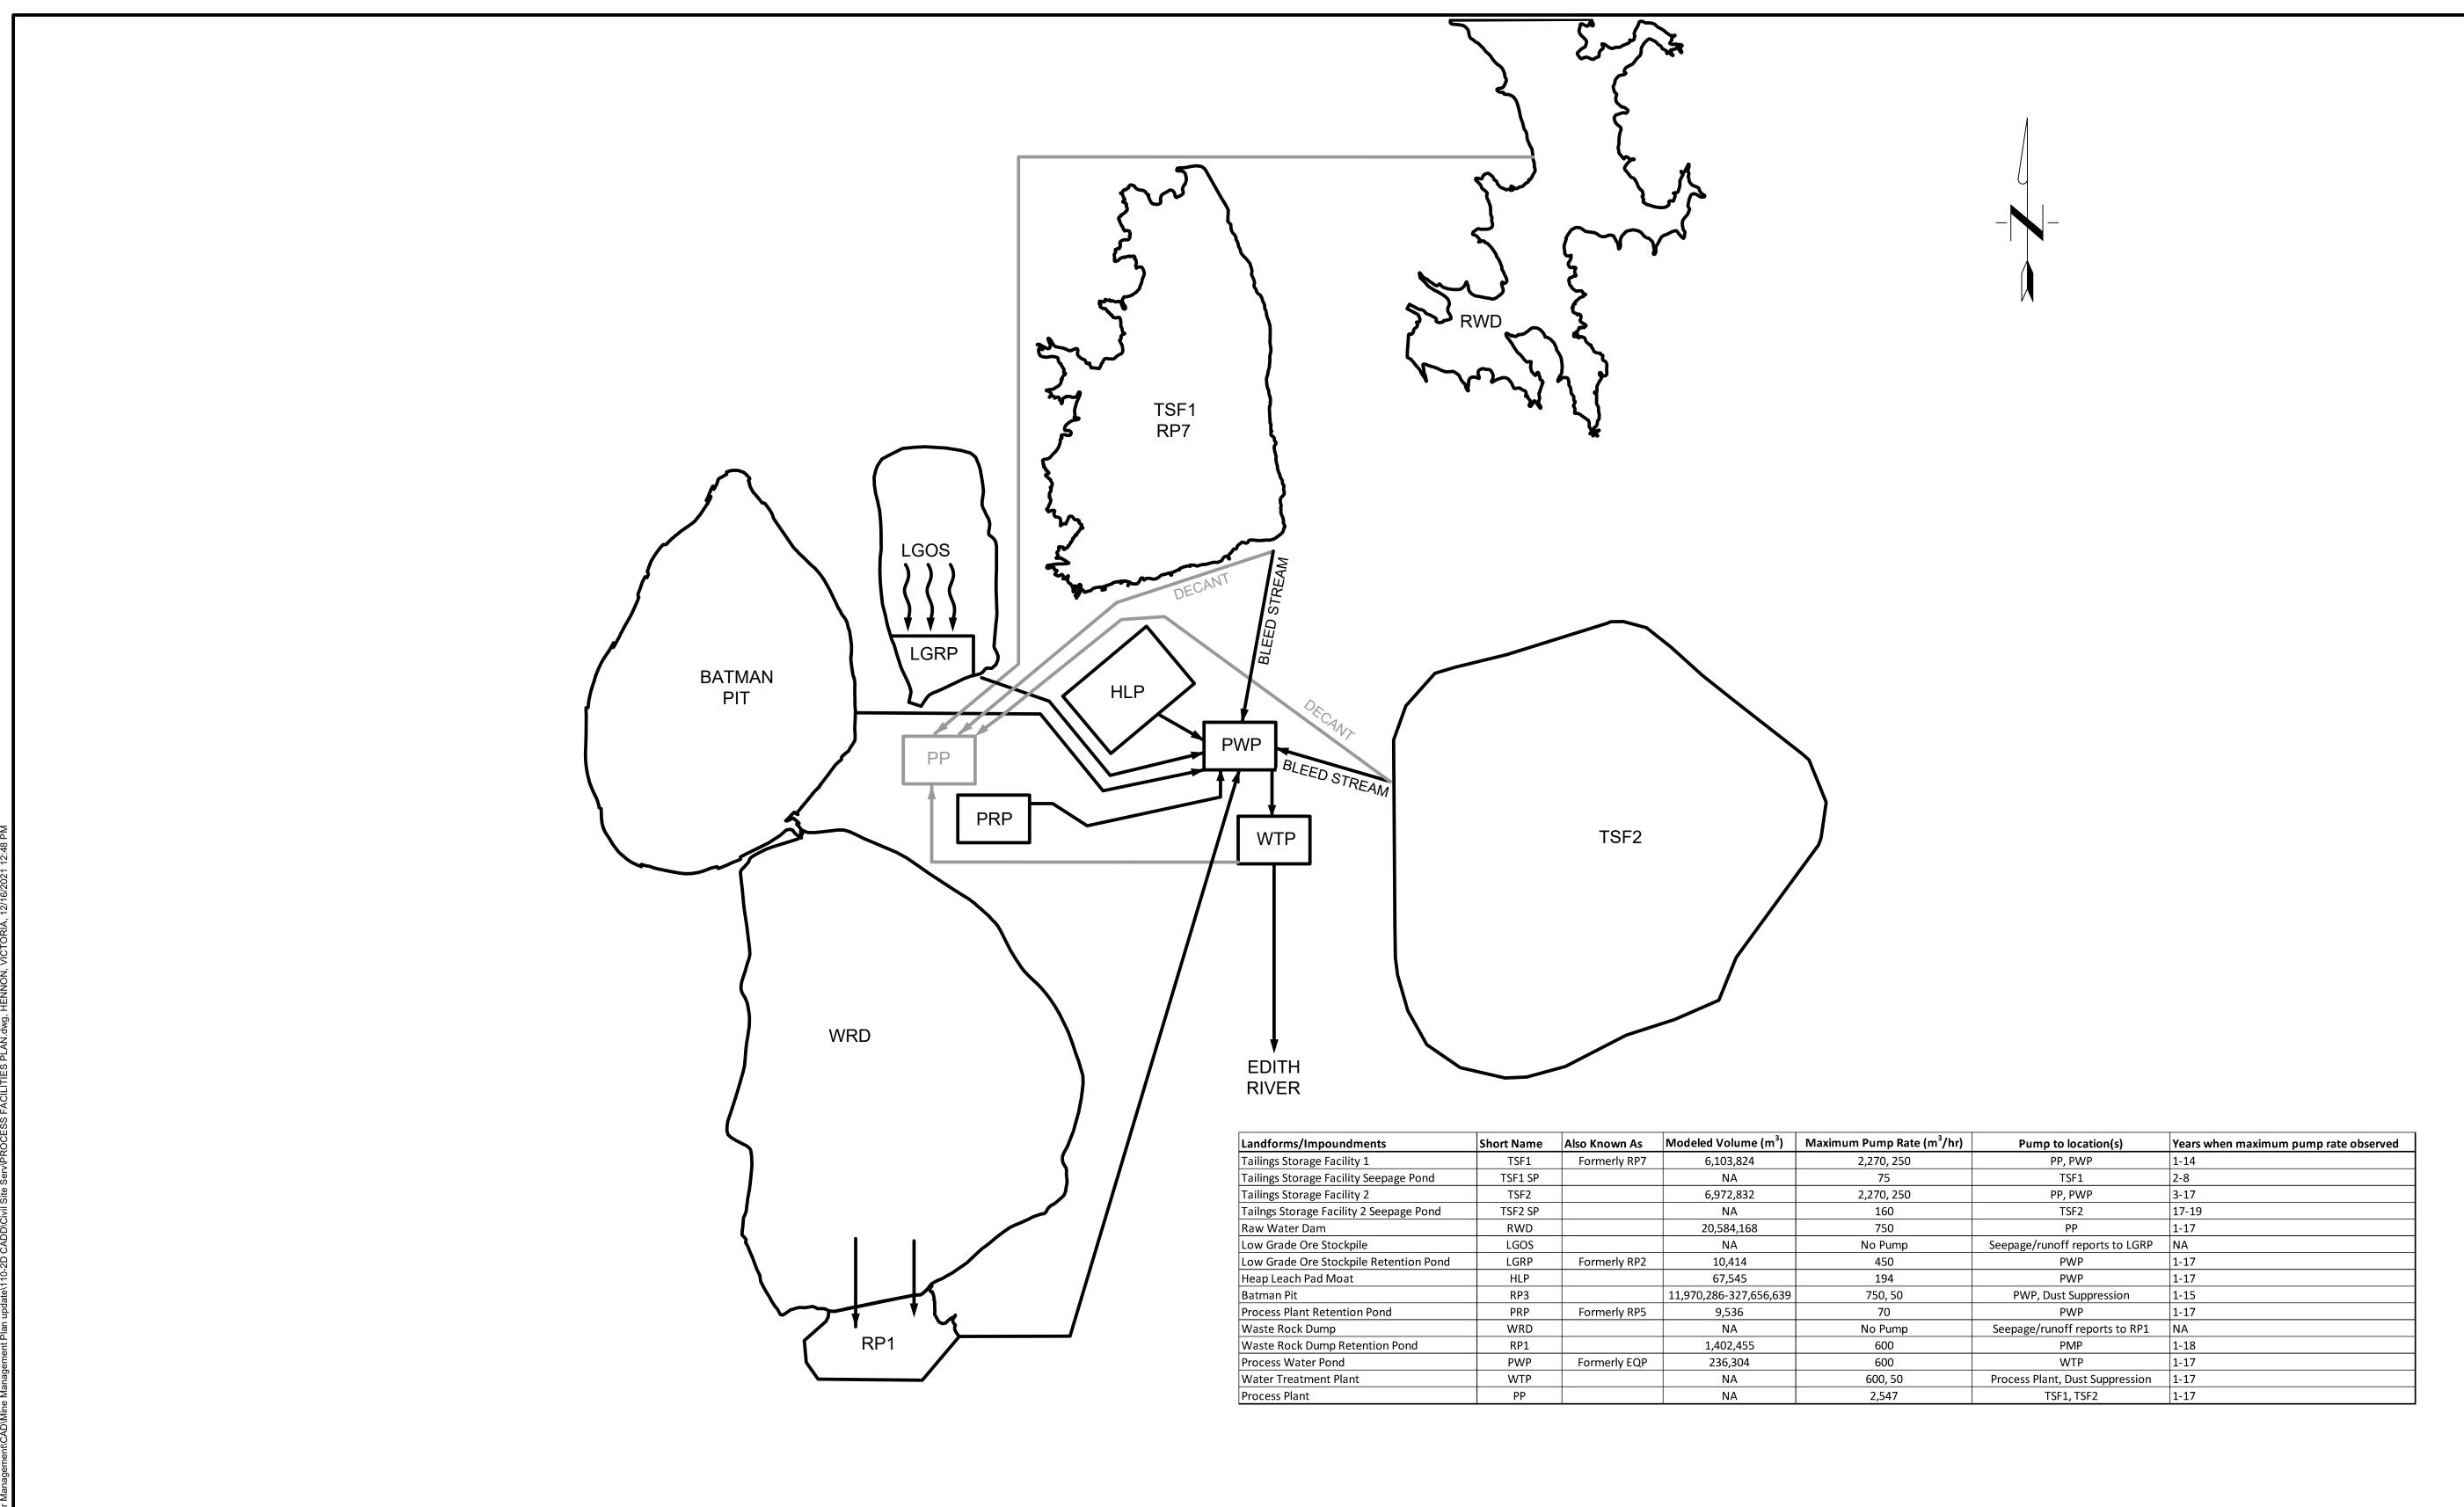

##	ENGINEER'S SEAL
##	
##	PRELIMINARY
##	
##	DRAWING
##	
##	
##	NOT ISSUED FOR
##	CONSTRUCTION
##	

REFERENCE

				Scale: AS SHOWN	Issued for:
				Designed by: CC	
				Drawn by: VH	
				Checked by: VS	
				Approved by: VS	
	2021 FEASIBILITY STUDY	VH	12/16/2021	THE CONTENT OF THIS DOCUMENT IS NOT INTENDED FOR THE USE OF, NOR IS IT	
c	ADDRESSED 08/2017 CLIENT COMMENTS	DF	11/03/2017	INTENDED TO BE RELIED UPON BY ANY PERSON, FIRM OR CORPORATION OTHER THAN THE CLIENT AND TETRA TECH. TETRA TECH DENIES ANY LIABILITY	
В	PRELIMINARY DESIGN ISSUED FOR REVIEW	JC	05/12/2017	WHATSOEVER TO OTHER PARTIES FOR DAMAGES OR INJURY SUFFERED BY SUCH THIRD PARTY ARISING FROM THE USE OF THIS DOCUMENT BY THEM, WITHOUT	
A	PRELIMINARY DESIGN	СС	04/21/2017	THE EXPRESSED WRITTEN AUTHORITY OF TETRA TECH AND OUR CLIENT. THIS DOCUMENT IS SUBJECT TO FURTHER RESTRICTIONS IMPOSED BY THE CONTRACT	
Rev	Description	BY	Date	BETWEEN THE CLIENT AND TETRA TECH AND THESE PARTIES PERMISSION MUST BE SOUGHT REGARDING THIS DOCUMENT IN ALL OTHER CIRCUMSTANCES.	į,
	REVISIONS			BE GOODITY REGISTRATING DOCUMENT IN ALL OTHER GIRCOMOTANGES.	





Issued by:

## SURFACE WATER MANAGEMENT PLAN WATER TREATMENT FLOW SCHEMATIC

D
REVISION

ect: 21 MT TODD FEASIBILITY STUDY DRAINAGE DESIGN	Project no.: 200-01299-21007		EXHIBIT 1	1
ation: IORTHERN TERRITORY, AUSTRAL	Date: 12/16/2021	SHEET 1 OF 1		